REHABILITATION OF THREE CULVERTS AT EVERGREEN WALK

501 EVERGREEN WAY SOUTH WINDSOR, CT May 11, 2020

PERMIT PLANS

OWNER

Prepared For:



Thousand Oaks Blvd., Suite 2200 Memphis, TN. 38118 (901) 761-7604


CONSULTANTS

Prepared By:








LOCATION MAP

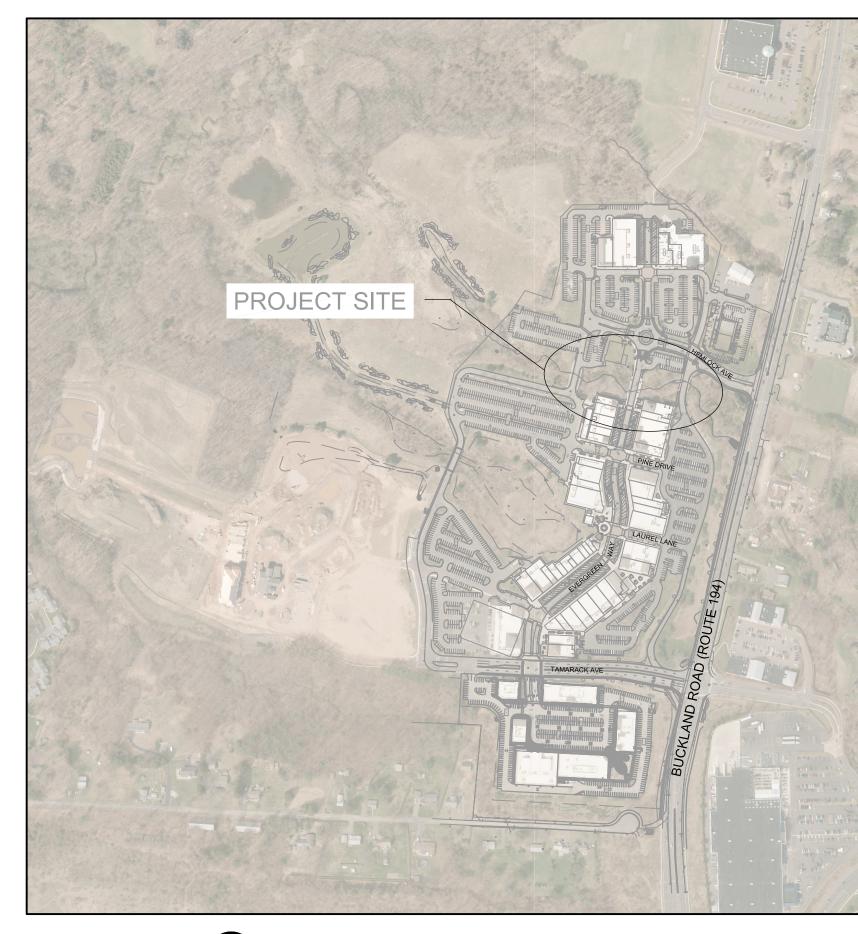




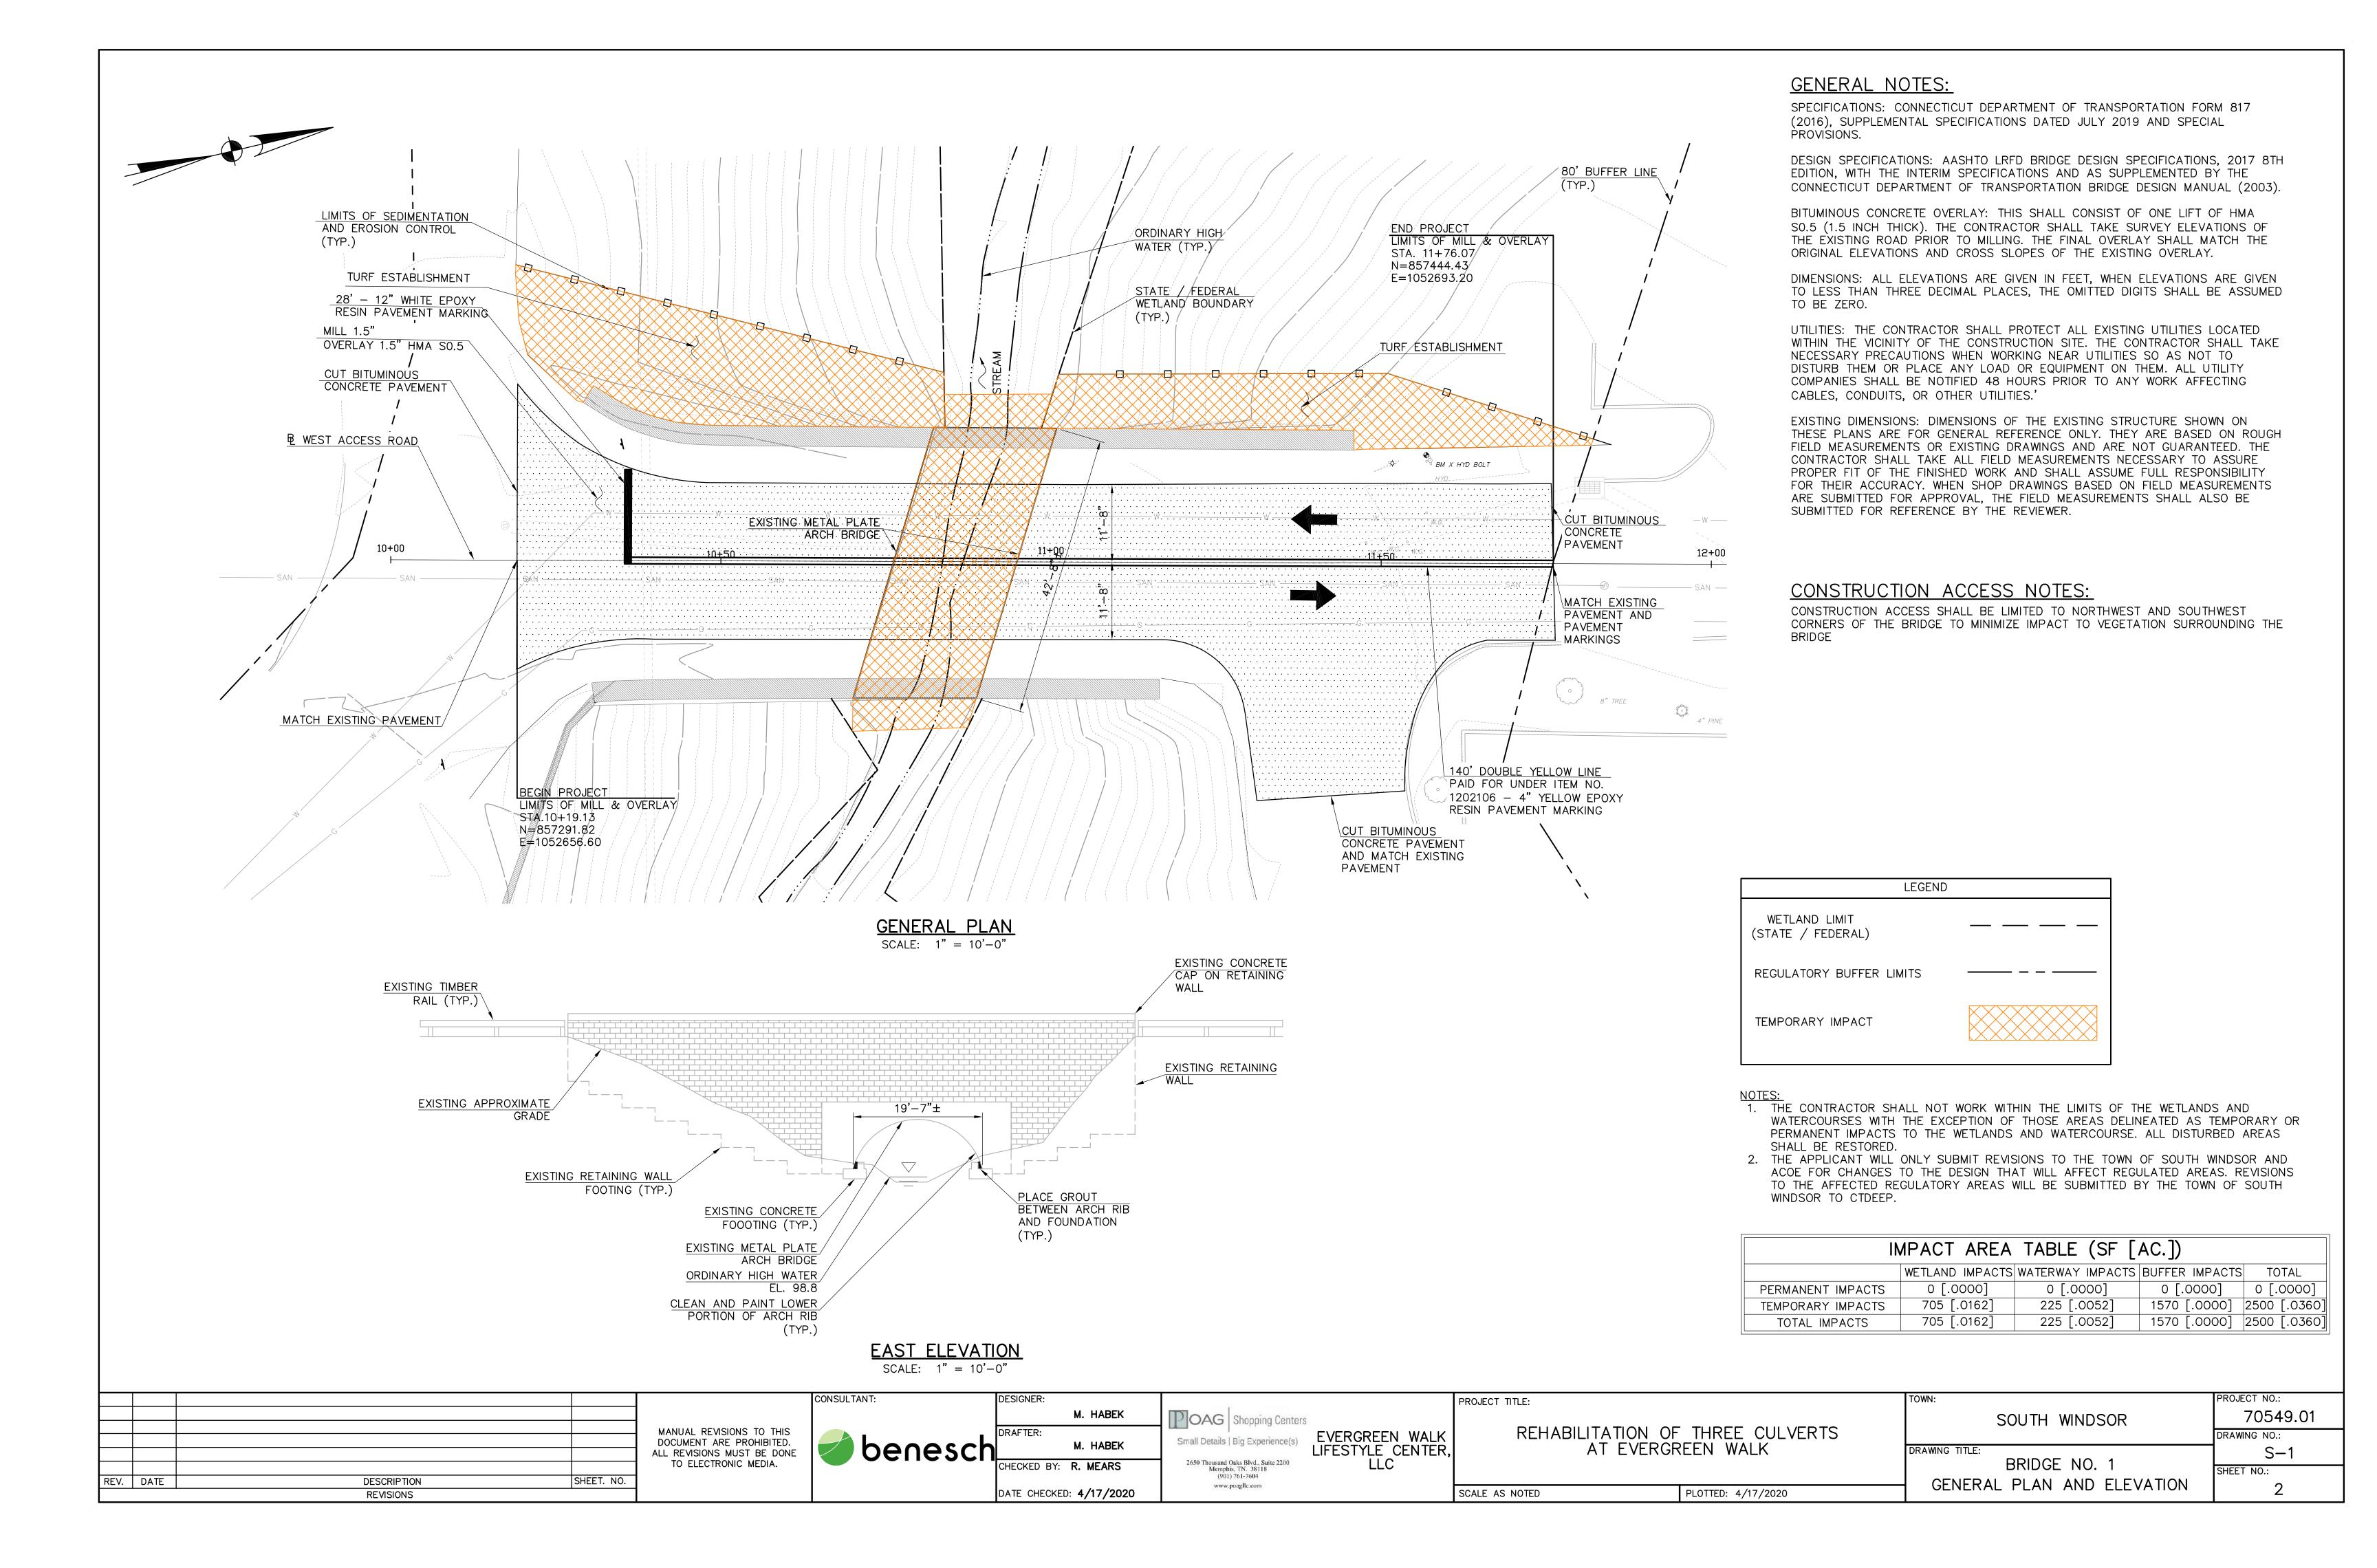

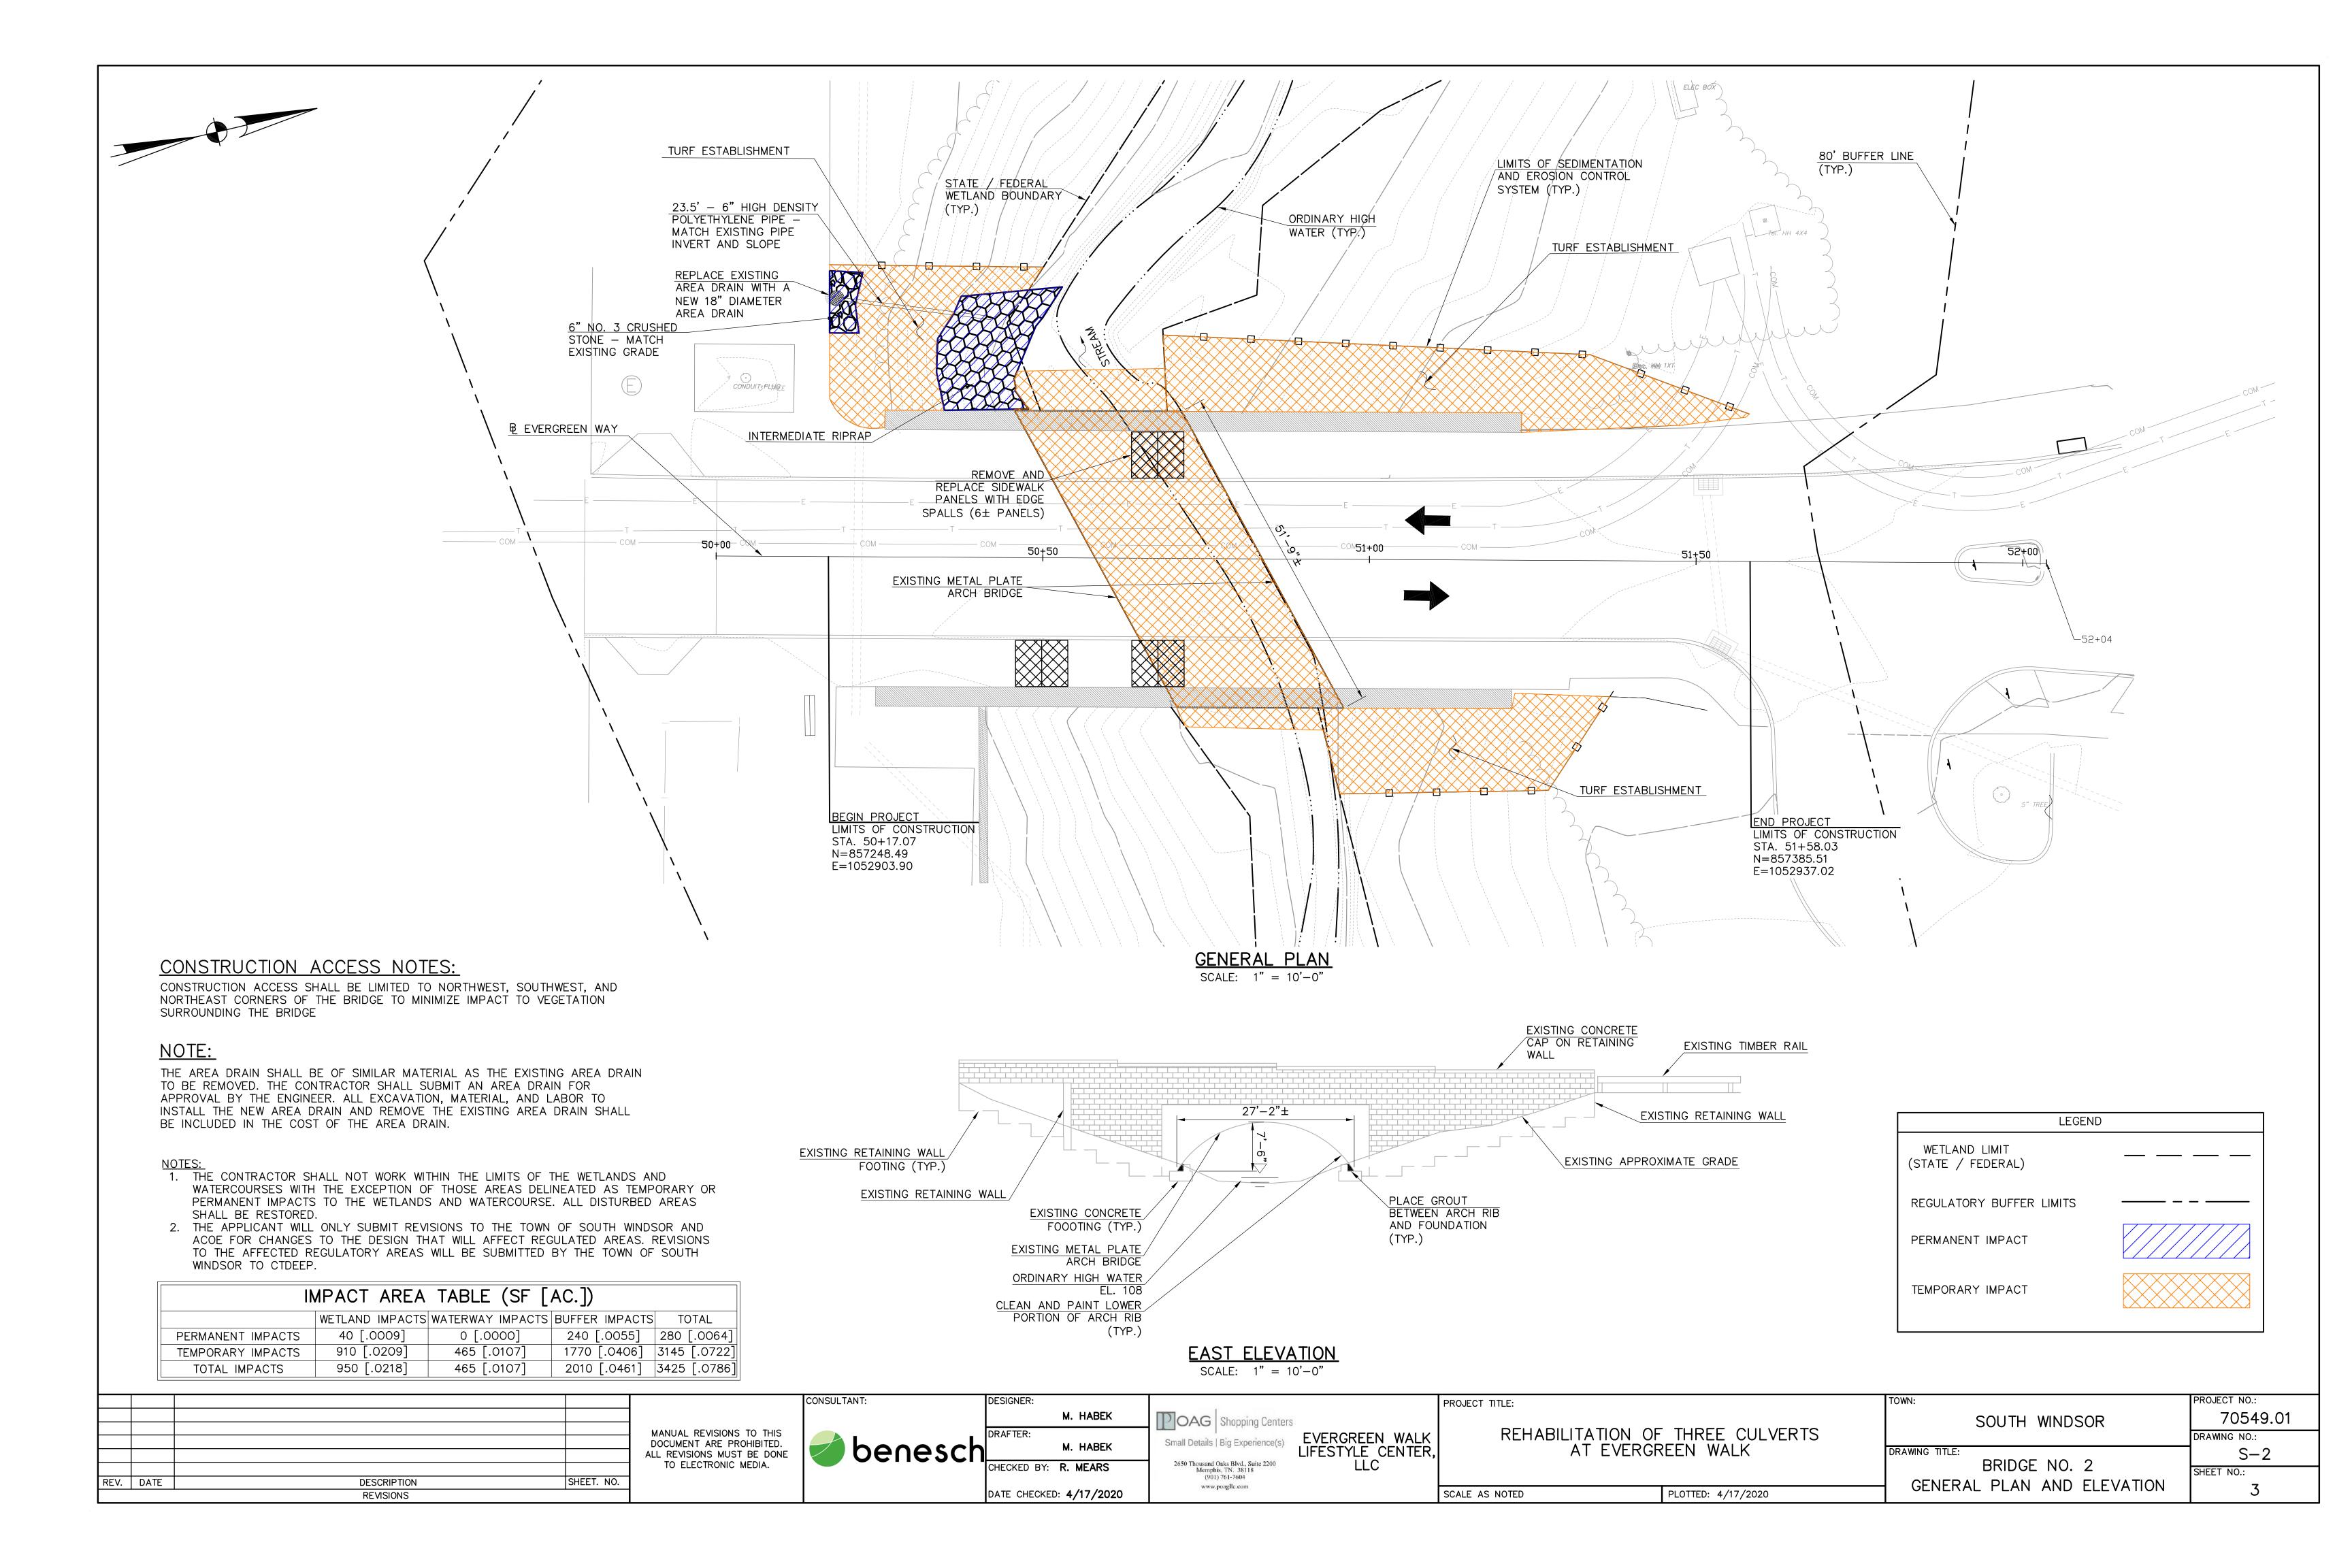

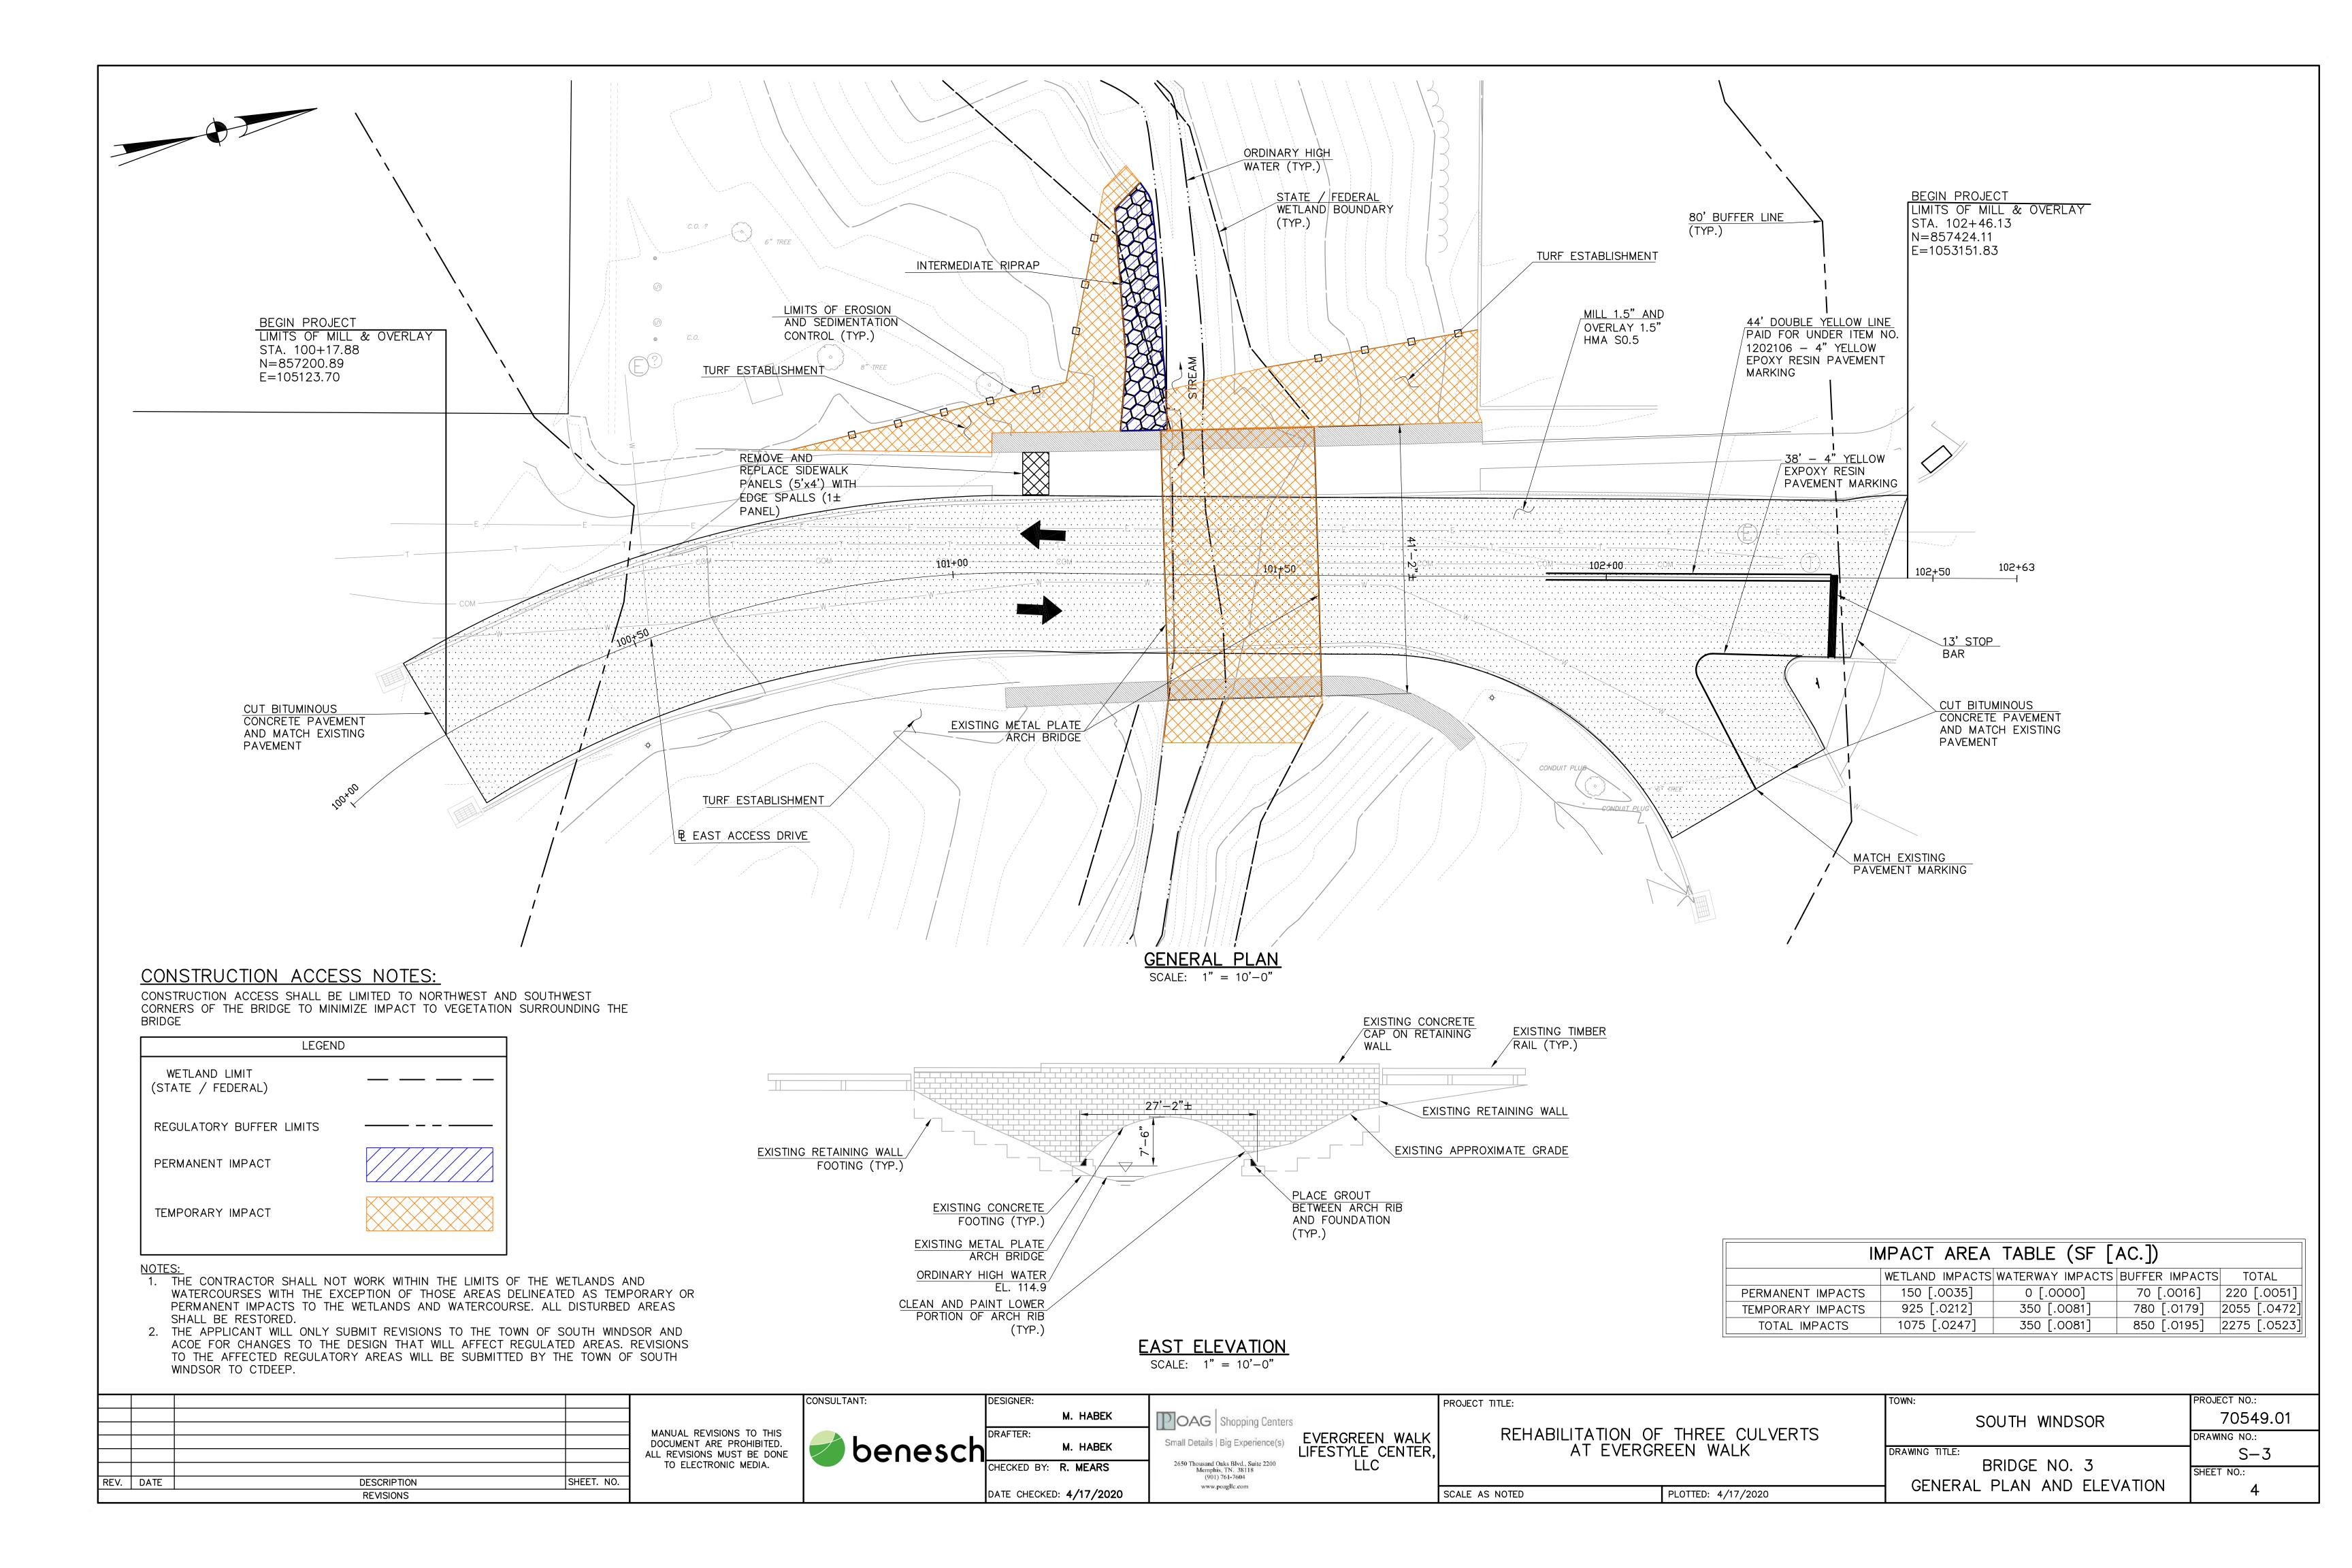

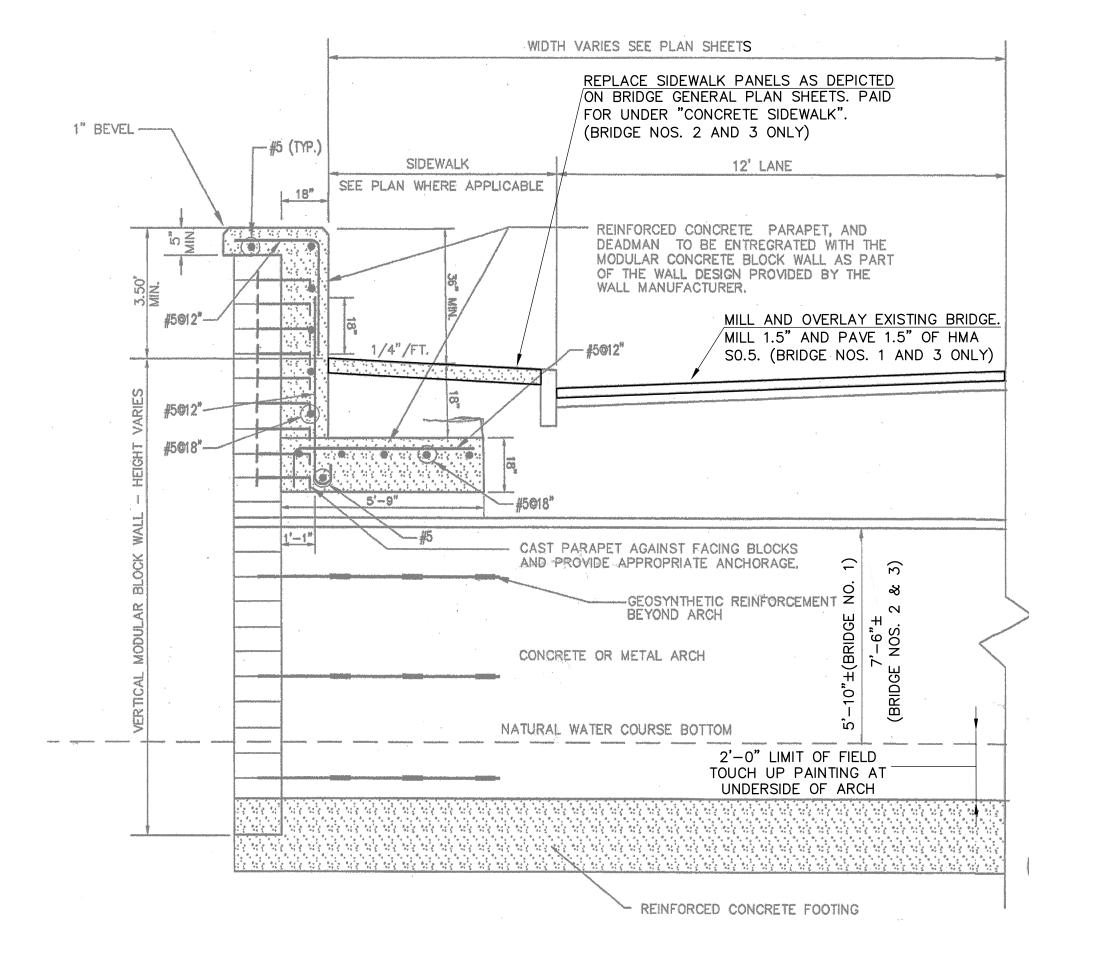

EXISTING HALF-SECTION

NOT TO SCALE

NOTE: SECTION FROM ORIGINAL DESIGN PLANS, PROVIDED FOR INFORMATION PURPOSES ONLY

CONSULTANT PROJECT TITLE: M. HABEK 70549.01 POAG Shopping Centers SOUTH WINDSOR REHABILITATION OF THREE CULVERTS MANUAL REVISIONS TO THIS EVERGREEN WALK DRAWING NO.: DOCUMENT ARE PROHIBITED. Small Details | Big Experience(s) M. HABEK AT EVERGREEN WALK benesch LIFESTYLE CENTER, DRAWING TITLE: S-4ALL REVISIONS MUST BE DONE 2650 Thousand Oaks Blvd., Suite 2200 Memphis, TN. 38118 TO ELECTRONIC MEDIA. CHECKED BY: R. MEARS TYPICAL BRIDGE SECTION SHEET NO.: (901) 761-7604 DESCRIPTION SHEET. NO. REV. DATE www.poagllc.com SCALE AS NOTED PLOTTED: 4/17/2020 DATE CHECKED: **4/17/2020 REVISIONS**

SUGGESTED SEQUENCE OF CONSTRUCTION:

BRIDGE 1:

1. INSTALL SEDIMENTATION AND EROSION CONTROL SYSTEM.


- 2. ESTABLISH PROTOCOL FOR CONTAINING RUST AND OTHER MATERIALS DURING HAND-TOOL CLEANING AS OUTLINED IN THE CONTRACTOR'S SUBMITTAL TO THE ENGINEER.
- 3. REMOVE DIRT, DEBRIS, AND WATER IN THE AREA BETWEEN THE EXISTING METAL PLATE ARCH AND THE EXISTING CONCRETE FOUNDATION.
- 4. REMOVE ANY AREAS OF RUST AT THE METAL PLATE ARCH WITHIN THE PAINTING LIMITS.
- 5. PRESSURE GROUT THE AREA BETWEEN THE EXISTING METAL PLATE ARCH AND THE EXISTING CONCRETE FOUNDATION.
- 6. FIELD TOUCH UP PAINT THE METAL PLATE ARCH AT THE SPRING LINE.
- 7. CLOSE ROADWAY AS ALLOWED IN THE PROSECUTION AND PROGRESS AND INSTALL APPLICABLE SIGNAGE.
- 8. MILL EXISTING OVERLAY TO LIMITS AND DEPTHS SHOWN ON THE PLAN. 9. INSTALL NEW OVERLAY MATCHING THE EXISTING ROADWAY ELEVATIONS AND
- CROSS SLOPES.
- 10. REMOVE ROAD CLOSURE SIGNAGE.
- 11. INSTALL FINAL PAVEMENT MARKINGS.
- 12. INSTALL TURF ESTABLISHMENT IN IMPACTED AREAS.
- 13. REMOVE SEDIMENTATION AND EROSION CONTROL SYSTEM.

BRIDGE 2:


- 1. INSTALL SEDIMENTATION AND EROSION CONTROL SYSTEM.
- 2. ESTABLISH PROTOCOL FOR CONTAINING RUST AND OTHER MATERIALS DURING HAND-TOOL CLEANING AS OUTLINED IN THE CONTRACTOR'S SUBMITTAL TO THE ENGINEER.
- 3. REMOVE DIRT, DEBRIS, AND WATER IN THE AREA BETWEEN THE EXISTING
- METAL PLATE ARCH AND THE EXISTING CONCRETE FOUNDATION. 4. REMOVE ANY AREAS OF RUST AT THE METAL PLATE ARCH WITHIN THE
- PAINTING LIMITS. 5. PRESSURE GROUT THE AREA BETWEEN THE EXISTING METAL PLATE ARCH
- AND THE EXISTING CONCRETE FOUNDATION.
- 6. FIELD TOUCH UP PAINT THE METAL PLATE ARCH AT THE SPRING LINE. 7. INSTALL AREA DRAIN, DRAINAGE PIPE AND INTERMEDIATE RIPRAP.
- 8. PLACE TEMPORARY SIDEWALK CLOSURE SIGNAGE.
- 9. REMOVE AND REPLACE DETERIORATED PANELS OF SIDEWALKS
- 10. REMOVE SIDEWALK CLOSURE SIGNAGE.
- 11. INSTALL TURF ESTABLISHMENT IN IMPACTED AREAS.
- 12. REMOVE SEDIMENTATION AND EROSION CONTROL SYSTEM

BRIDGE 3:

- 1. INSTALL SEDIMENTATION AND EROSION CONTROL SYSTEM.
- 2. ESTABLISH PROTOCOL FOR CONTAINING RUST AND OTHER MATERIALS DURING HAND-TOOL CLEANING AS OUTLINED IN THE CONTRACTOR'S SUBMITTAL TO THE ENGINEER.
- 3. REMOVE DIRT, DEBRIS, AND WATER IN THE AREA BETWEEN THE EXISTING
- METAL PLATE ARCH AND THE EXISTING CONCRETE FOUNDATION. 4. REMOVE ANY AREAS OF RUST AT THE METAL PLATE ARCH WITHIN THE
- PAINTING LIMITS. 5. PRESSURE GROUT THE AREA BETWEEN THE EXISTING METAL PLATE ARCH
- AND THE EXISTING CONCRETE FOUNDATION.
- 6. FIELD TOUCH UP PAINT THE METAL PLATE ARCH AT THE SPRING LINE. INSTALL INTERMEDIATE RIPRAP AS SHOWN ON THE PLANS.
- 8. CLOSE ROADWAY AND SIDEWALK AS ALLOWED IN THE PROSECUTION AND
- PROGRESS AND INSTALL APPLICABLE SIGNAGE.
- 9. REMOVE AND REPLACE DETERIORATED PANELS OF SIDEWALKS. 10. MILL EXISTING OVERLAY TO LIMITS AND DEPTHS SHOWN ON THE PLAN.
- 11. INSTALL NEW OVERLAY MATCHING THE EXISTING ROADWAY ELEVATIONS AND
- CROSS SLOPES. 12. REMOVE ROAD AND SIDEWALK CLOSURE SIGNAGE.
- 13. INSTALL FINAL PAVEMENT MARKINGS.
- 14. INSTALL TURF ESTABLISHMENT IN IMPACTED AREAS.
- 15. REMOVE SEDIMENTATION AND EROSION CONTROL SYSTEM

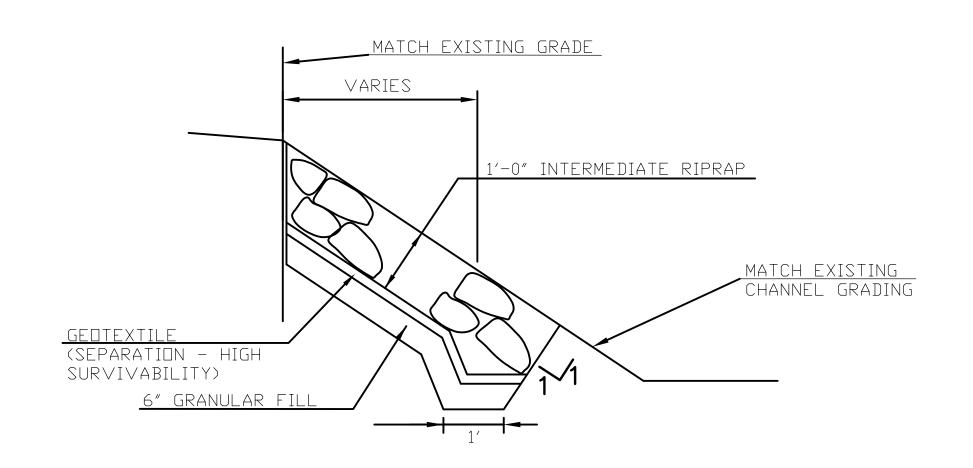


INTERMEDIATE RIPRAP FOR SLOPE PROTECTION N.T.S.

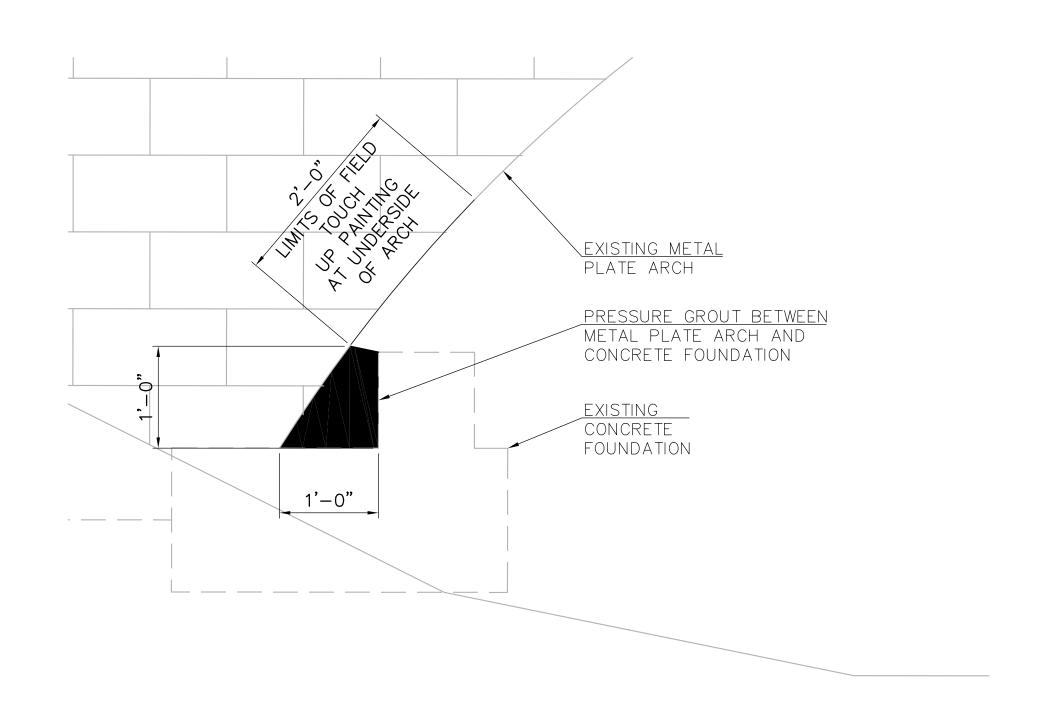


PAINTING AND GROUTING DETAIL SCALE: 1" = 1'-0"

NOTES:

- 1. WATER MAY BE PRESENT WITHIN VOID BETWEEN EXISTING CONCRETE FOUNDATION AND ARCH RIB. REMOVAL OF WATER IF PRESENT SHALL BE PAID FOR UNDER "REMOVAL OF DIRT AND DEBRIS"
- 2. CONTRACTOR SHALL SUBMIT PLAN INDICATING THEIR PROPOSED METHOD FOR CONTAINING RUST AND OTHER MATERIALS DURING HAND—TOOL CLEANING, PAINTING, AND PRESSURE GROUTING. REFER TO SPECIAL PROVISIONS FOR ADDITIONAL INFORMATION.

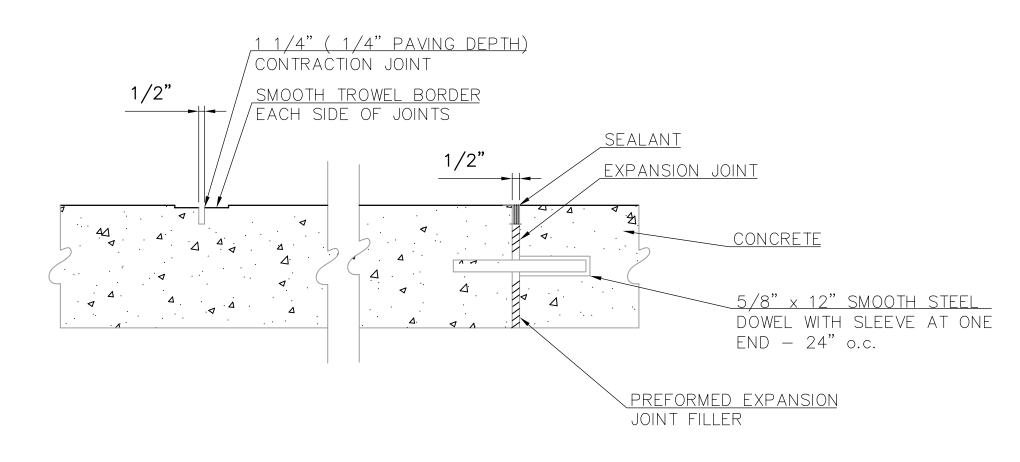

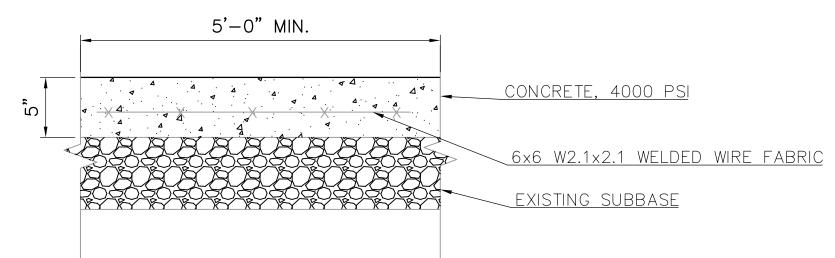

70549.01

S-5

DRAWING NO.:

SHEET NO.:

SOUTH WINDSOR

REPAIR DETAILS

DRAWING TITLE:

TYPICAL SIDEWALK DETAIL SCALE: 1" = 1'-0"

NOTES:

- 1. REMOVAL OF SIDEWALK PANELS TO BE PAID FOR UNDER THE ITEM "REMOVAL OF CONCRETE SIDEWALK"
- 2. INSTALLATION OF NEW SIDEWALK PANELS TO BE PAID FOR UNDER THE ITEM "CONCRETE SIDEWALK"

			_	CONSULTANT:	DESIGNER:		PROJECT TITLE:		
					M. HABEK	POAG Shopping Centers			
			MANUAL REVISIONS TO THIS DOCUMENT ARE PROHIBITED. ALL REVISIONS MUST BE DONE TO ELECTRONIC MEDIA.	benesch	DRAFTER: M. HABEK		EVERGREEN WALK LIFESTYLE CENTER, LLC	REHABILITATION OF THREE CULVERTS AT EVERGREEN WALK	
REV. DATE	DESCRIPTION	SHEET. NO.			CHECKED BY: R. MEARS	2650 Thousand Oaks Blvd., Suite 2200 Memphis, TN. 38118 (901) 761-7604 www.poagllc.com			
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