

355 Research Parkway Meriden, CT 06450 (203) 630-1406 (203) 630-2615 Fax



Date: 03-29-2023




XPANSION GATEWAY BUILDIN 40 KENNED SOUTH WINDSO

Reviewed: Project No.:

2001752.14 03/29/2023

PERMIT

DEMOLITION FLOOR PLAN

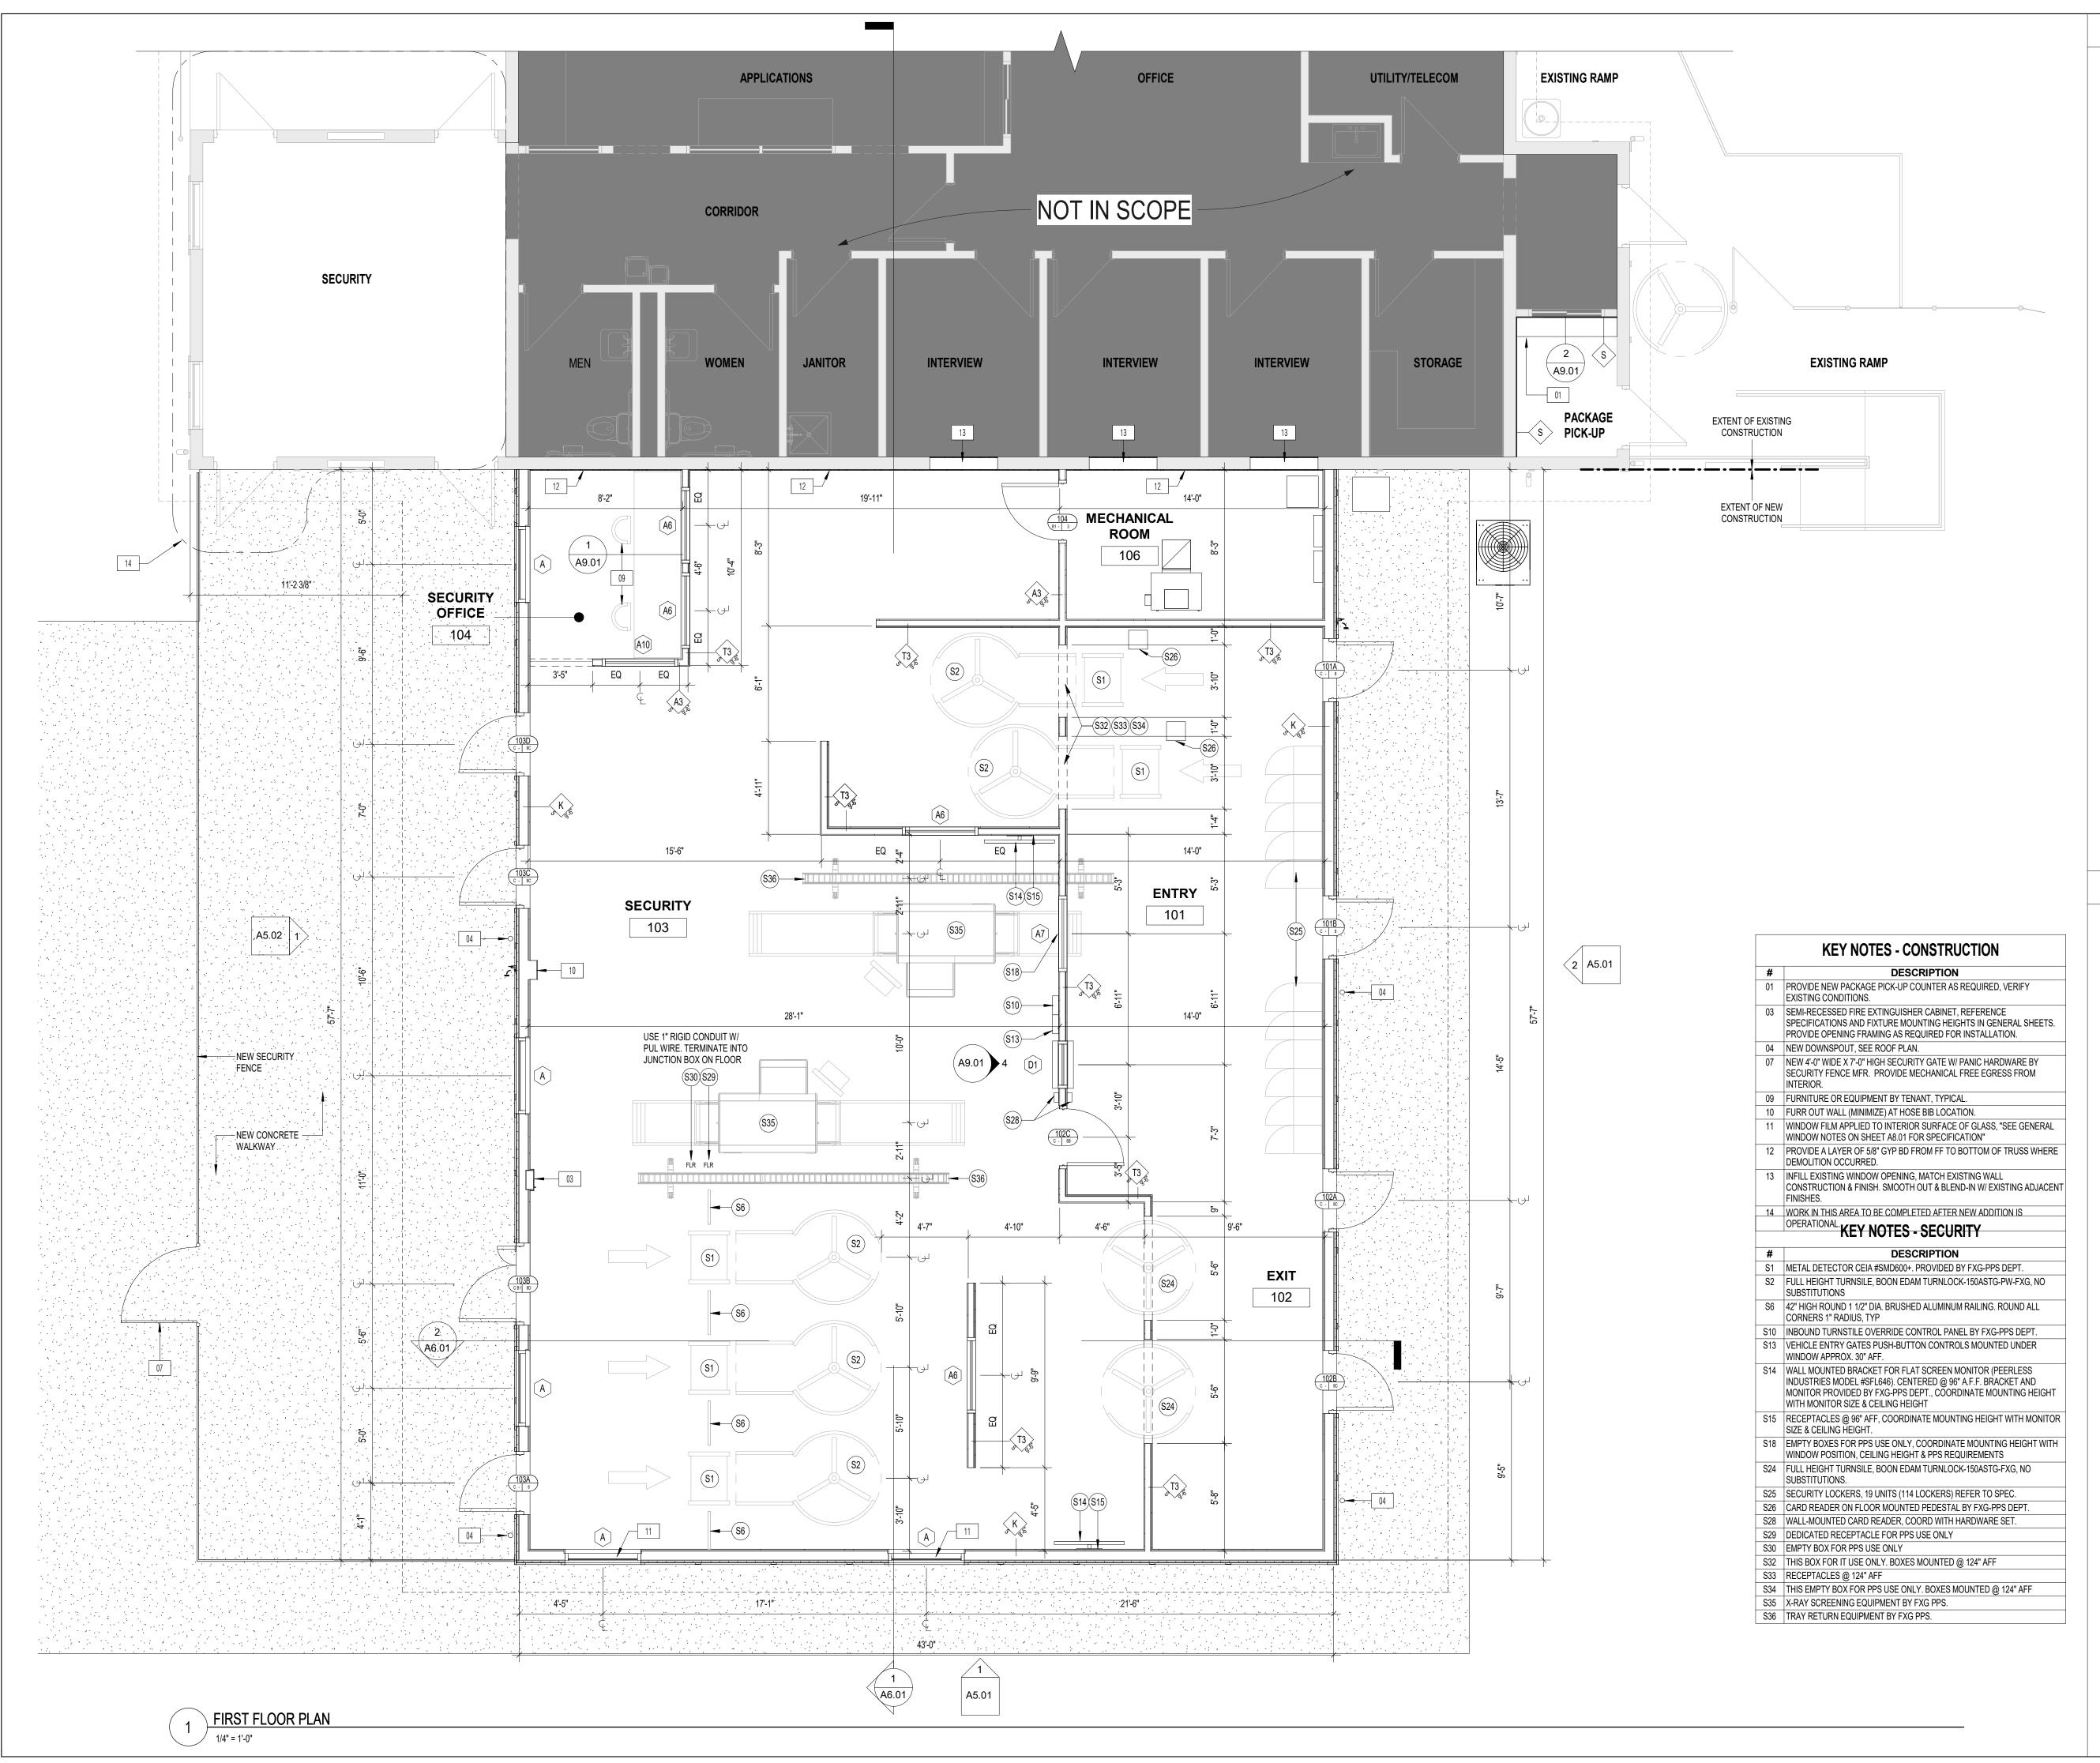

FLOOR PLAN GENERAL NOTES

- 1. FIELD VERIFY ALL DIMENSIONS AND ADVISE ARCHITECT OF ANY DISCREPANCIES PRIOR TO COMMENCEMENT OF WORK OR PROCUREMENT OF DIMENSION SENSITIVE PRODUCTS.
- 2. DIMENSIONS ARE TO THE FACE OF STUDS, UNLESS OTHERWISE
- GYPSUM WALLBOARD
 - WORK SHALL COMPLY WITH ASTM C840-STANDARD SPECIFICATIONS FOR APPLICATION AND FINISHING OF
 - GYPSUM BOARD. GYPSUM WALLBOARD TO RECEIVE LEVEL 4 FINISHES PER ASTM C840. SURFACE SHALL BE SMOOTH AND READY TO RECEIVE FINISH MATERIAL. PROVIDE MOISTURE RESISTANT GWB IN RESTROOM WETWALLS AND AT SINK COUNTERS.
 - GYPSUM WALLBOARD NOT TO RECEIVE FINISHES SHALL BE FINISHED TO LEVEL 2 FINISH PER ASTM C840
 - WATER RESISTANT GYPSUM TO BE 5/8" DENS ARMOR PLUS OR EQUAL COMPLYING WITH ASTM C1178, C1288 OR
 - ALL GYPSUM WALLBOARD IS TO BE 5/8" THICK UNLESS NOTED OTHERWISE. UNIFORM LOAD AT PARTITIONS IS 5 PSF WITH ALLOWABLE DEFLECTION OF L/240 UNLESS SHELVING AND EQUIPMENT IS PROPOSED FOR ATTACHMENT. ALL PARTITIONS TO BE BUILT TO BOTTOM OF WOOD TRUSS SHALL
 - ENCOMPASS ANY STRUCTURE SUCH AS JOISTS AND BEAMS THAT MAY NEED TO BE FRAMED OUT TO PROVIDE DRYWALL. ALL PENETRATIONS SHALL BE SEALED AS REQUIRED.
- PROVIDE BRACING PER MANUFACTURER RECOMMENDATIONS OF ALL PARTITIONS THAT DO NOT EXTENDED FULL HEIGHT TO UNDERSIDE OF STRUCTURE ABOVE.
- ALL PARTITION FRAMING THAT EXTENDS FROM SLAB TO STRUCTURE ABOVE. PROVIDE GALVANIZED STEEL SHEET DEEF LEG DEFLECTION TRACK (20 GA), 'SLP-TRK' BY SLIP TRACK SYSTEMS, INC. SECURE TO STRUCTURE WITH FASTENERS AT 2'-0' O.C. MAXIMUM. DO NOT SECURE TRACK TO VERTICAL STUDS. PROVIDE MINIMUM 2 1/2" TO TOP OF STUD.
- 8. ALL BOTTOM TRACK RUNNERS TO BE HELD IN PLACE WITH FASTENERS AT 2'-0" O.C. MAX. WITH HILTI POWDER DRIVER ANCHORS #2388, 0.145" DIA. SHANK WITH 1 1/8" MIN. PENETRATION.
- PROVIDE HORIZONTAL BRIDGING IN ALL PENETRATION FRAMING AT MAXIMUM OF 6'-0" O.C. VERTICALLY. UNLESS OTHERWISE 10. PROVIDE ACOUSTICAL SEALANT AT THE CONNECTION OF ALL
- GYP. BD. TO DECK OR SLAB CONDITIONS. HOLD GYP. BD. 3/8" OFF STRUCTURE FOR SEALANT. PROVIDE J-BEAD AT ALL SEALED
- 11. PER CODE SECTION 720, ALL CONCEALED AND EXPOSED INSULATION SHALL HAVE A CLASS A FLAME SPREAD AND SMOKE DEVELOPMENT INDEX PER ASTM E 84.
- 12. INSULATING MATERIALS WHEN INSTALLED IN BUILDINGS OF ANY TYPE CONSTRUCTION SHALL COMPLY WITH LOCAL JURISDICTION
- 13. ALL PLYWOOD & BLOCKING TO BE FIRE RETARDANT TREATED. 14. PROVIDE CONTROL JOINTS IN ALL WALLS EXCEEDING 30' IN
- LENGTH AND HEIGHT AND EVERY 30' THEREAFTER, USG#093 ALL DOORS SHALL BE LOCATED WITH HINGE SIDE OF FRAME 4" OFF FINISHED WALL, (AT CORNER CONDITION), UNLESS
- OTHERWISE NOTED. 16. 5% BUT NOT LESS THAN 1% OF SEATING AND STANDING SURFACES AT DINING SURFACES SHALL BE ACCESSIBLE.
- 17. SEE STRUCTURAL DRAWINGS FOR SLAB AND FOUNDATION INFORMATION.
- 18. PROVIDE FIRE EXTINGUISHERS. SEE FIRE EXTINGUISHER SPECIFICATION. SEE EGRESS & FLOOR PLANS FOR LOCATIONS COORDINATE LOCATION OF FIRE EXTINGUISHERS WITH TENANT AND LOCAL FIRE OFFICIALS. PORTABLE FIRE EXTINGUISHERS SHALL BE PROVIDED IN ACCORDANCE WITH N.F.P.A. 10. THE FIRE EXTINGUISHERS SHALL BE ARRANGED WITH A MAXIMUM TRAVEL DISTANCE TO AN EXTINGUISHER NOT TO EXCEED 50 FEET.

EXISTING BUILDING NOTES

- NEW CONSTRUCTION ARE TO BE PATCHED / REPAIRED TO MATCH EXISTING OR ADJACENT NEW CONSTRUCTION.
- ALL EXISTING PARTITIONS INDICATED ON THE EGRESS PLANS TO BE SMOKE / FIRE RATED NEED TO BE MODIFIED TO MEET REQUIREMENTS AS REQUIRED TO COMPLY WITH DETAILS SHOWN FOR NEW PARTITION
- WHERE NEW PARTITIONS ARE ALIGNED WITH EXISTING, ALIGN FROM FINISH FACE OF BOTH. IF PARTITIONS ARE TO ATTACH, MAKE TRANSITION SMOOTH UNIFORM SURFACE.
- ALL PENETRATIONS IN EXISTING WALLS OR FLOORS SHALL BE SEALED FOR SMOKE / FIRE RATINGS AS REQUIRED
- PROVIDE ANY OPENINGS REQUIRED FOR MECHANICAL. ELECTRICAL, PLUMBING AND TECHNOLOGY INSTALLATION OF NEW CONSTRUCTION AND REPAIR TO MATCH EXISTING.

PATCH AND LEVEL EXISTING FLOOR / CONCRETE SLAB AT ALL

LOCATIONS AS REQUIRED. PREPARE EXISTING SURFACES TO RECEIVE NEW FINISHES AS

KEY PLAN

TRUE NORTH

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WAY BUILDI 40 KENNED SOUTH WINDS(

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FLOOR PLAN

Sheet No.

- CONTRACTOR TO VERIFY EXACT TYPE OF BASE, TOP AND TRANSITION DETAIL NEEDED FOR WALLS UNLESS PARTIAL HEIGHT WALLS OR OTHER WALLS THAT ARE DEFINED IN OTHER PARTS OF THE DOCUMENTS. WALL TYPE 'Z' DENOTES A WALL THAT IS EXPLAINED BY A WALL SECTION AND NOT THE TAG. SEE THE SECTION THAT IS
- WALL TYPES THAT TERMINATE AT "STRUCTURE" ARE REFERRING TO BUILDING STRUCTURE AND NOT A STRUCTURAL CAP FOR THE ROOM UNLESS THERE IS A HEIGHT ASSOCIATED WITH THE TAG AS SHOWN ABOVE TO LOCATE A CAP.
- SEE PARTITION DETAILS SHEET FOR HEAD OF WALL DETAILS AS INDICATED ON PER TAGS

GWB CEILING

ROD, TYP EACH SIDE


CONT. 1/2" CAULK JOINT W/BACKER

INSULATION BATT AS INDICATED -

2X WOOD WALL STUD PER WALL

1" = 1'-0"

BASIS OF DESIGN: GWB IS 5/8" UNLESS DESIGN NOTES OTHERWISE

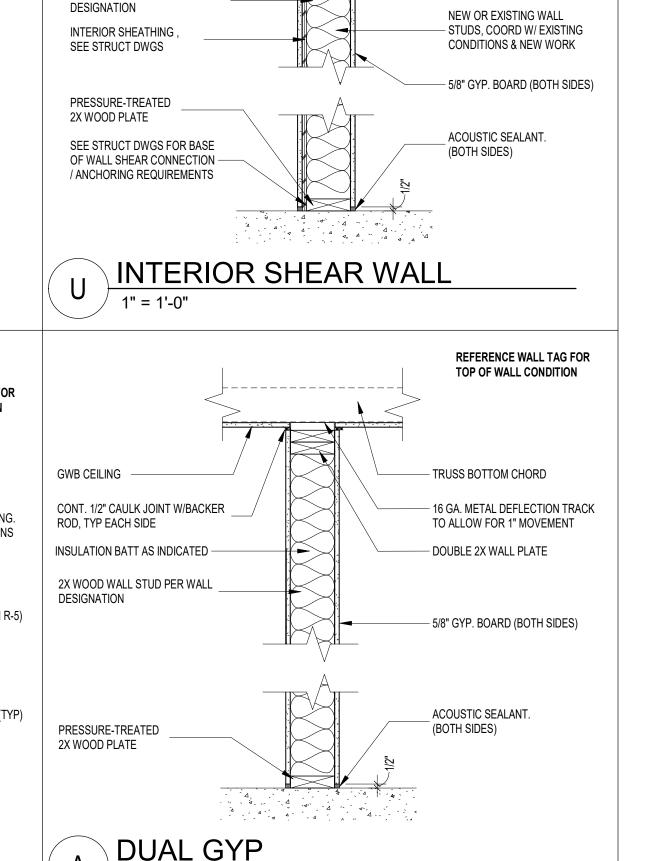

REFERENCE WALL TAG FOR TOP OF WALL CONDITION

TRUSS BOTTOM CHORD

- DOUBLE 2X WALL PLATE

— 16 GA. METAL DEFLECTION TRACK

TO ALLOW FOR 1" MOVEMENT

GENERAL PARTITION NOTES

- WALL TYPES LISTED REPRESENT SEVERAL TYPES OF WALL CONSTRUCTION, ALL OF WHICH MAY NOT BE USED ON THIS PROJECT. REFER TO FLOOR PLANS FOR WALL TYPE DESIGNATIONS.
- EXTEND ALL WOOD STUDS AND GYPSUM BOARD TO 6" ABOVE CEILING UNLESS OTHERWISE NOTED.
- 3. STUD SPACING SHALL BE 16" O.C. UNLESS OTHERWISE NOTED.
- ALL DIMENSIONS ARE TO FACE OF STUD, UNLESS OTHERWISE
- PROVIDE BRACING PER MANUFACTURER'S RECOMMENDATIONS FOR ALL PARTITIONS THAT DO NOT EXTEND FULL HEIGHT TO UNDERSIDE OF STRUCTURE ABOVE.
- ALL WALLS THAT EXTEND TO STRUCTURE ABOVE SHALL HAVE A DOUBLE TOP PLATE.
- ALL BOTTOM PLATES TO BE PRESSURE-TREATED. ANCHOR TO SLAB AS REQUIRED.
- PROVIDE HORIZONTAL BRIDGING IN ALL PARTITION FRAMING AT A MAXIMUM OF 5'-0" O.C. VERTICALLY. G.C. TO VERIFY WITH STUD MANUFACTURER TO DETERMINE IF HORIZONTAL BRIDGING IS REQUIRED FOR STUD WALLS WITH GYPSUM WALL BOARD ON BOTH SIDES THAT EXTEND TO THE ROOF DECK ABOVE.
- 9. ALL GYPSUM WALL BOARD TO BE 5/8" THICK UNLESS OTHERWISE
- PROVIDE ASTM C840 LEVEL 4 FINISH ON ALL GWB PARTITIONS TO RECEIVE TENANT FINISHES. RATED PARTITIONS TO RECEIVE FINISH LEVEL AS DIRECTED BY U.L. DESIGN. (MINIMUM LEVEL 4)
- 11. UNIFORM LOAD AT CEILINGS IS 10 PSF.
- 12. UNIFORM LATERAL LOAD AT PARTITIONS IS 5 PSF WITH L/240 DEFLECTION.
- 13. THERMAL AND ACOUSTIC INSULATION, OTHER THAN FOAM PLASTICS, HAVING A FLAME SPREAD INDEX OF NOT MORE THAN 25 ARE ALLOWED IN TYPE I AND TYPE II CONSTRUCTION. IF THIS INSULATION IS PLACED BETWEEN TWO LAYERS OF NONCOMBUSTABLE MATERIALS WITHOUT AN INTERVENING AIR SPACE, THE INSULATION SHALL BE ALLOWED TO HAVE A FLAME SPREAD INDEX OF NOT MORE THAN 100.
- INSULATING MATERIALS, WHERE EXPOSED ABOVE THE CEILING, SHALL HAVE A FLAME SPREAD INDEX OF NOT MORE THAN 25 AND A SMOKE-DEVELOPED INDEX OF NOT MORE THAN 450.
- THERMAL AND SOUND INSULATION AND COVERING WHICH ARE INSTALLED IN CONCEALED AND EXPOSED SPACES AND AS COVERING OVER PIPE AND TUBING SHALL BE TESTED IN ACCORDANCE WITH AMERICAN SOCIETY OF TESTING MATERIALS (ASTM) E 84 AND HAVE A FLAME SPREAD OF 0-25 AND A SMOKE INDEX OF 0-450.



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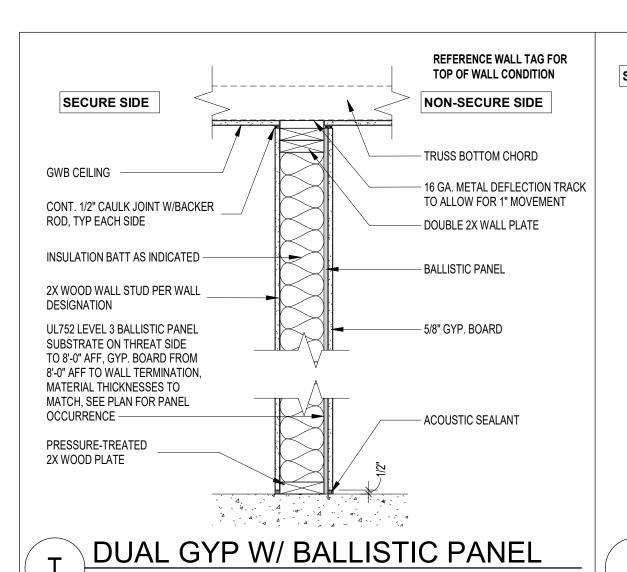
XPANSION WAY BUILDII 40 KENNED SOUTH WINDSC **GATEWAY**


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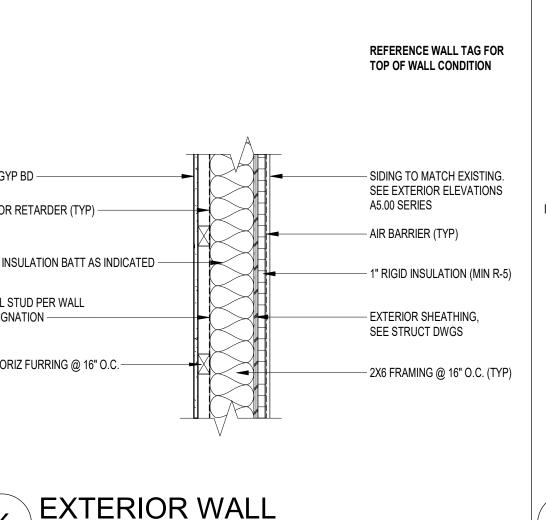
WALL TYPES & DETAILS


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A1.10







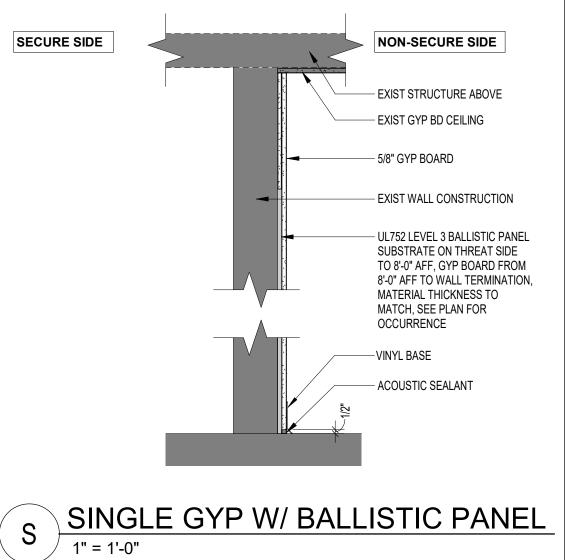

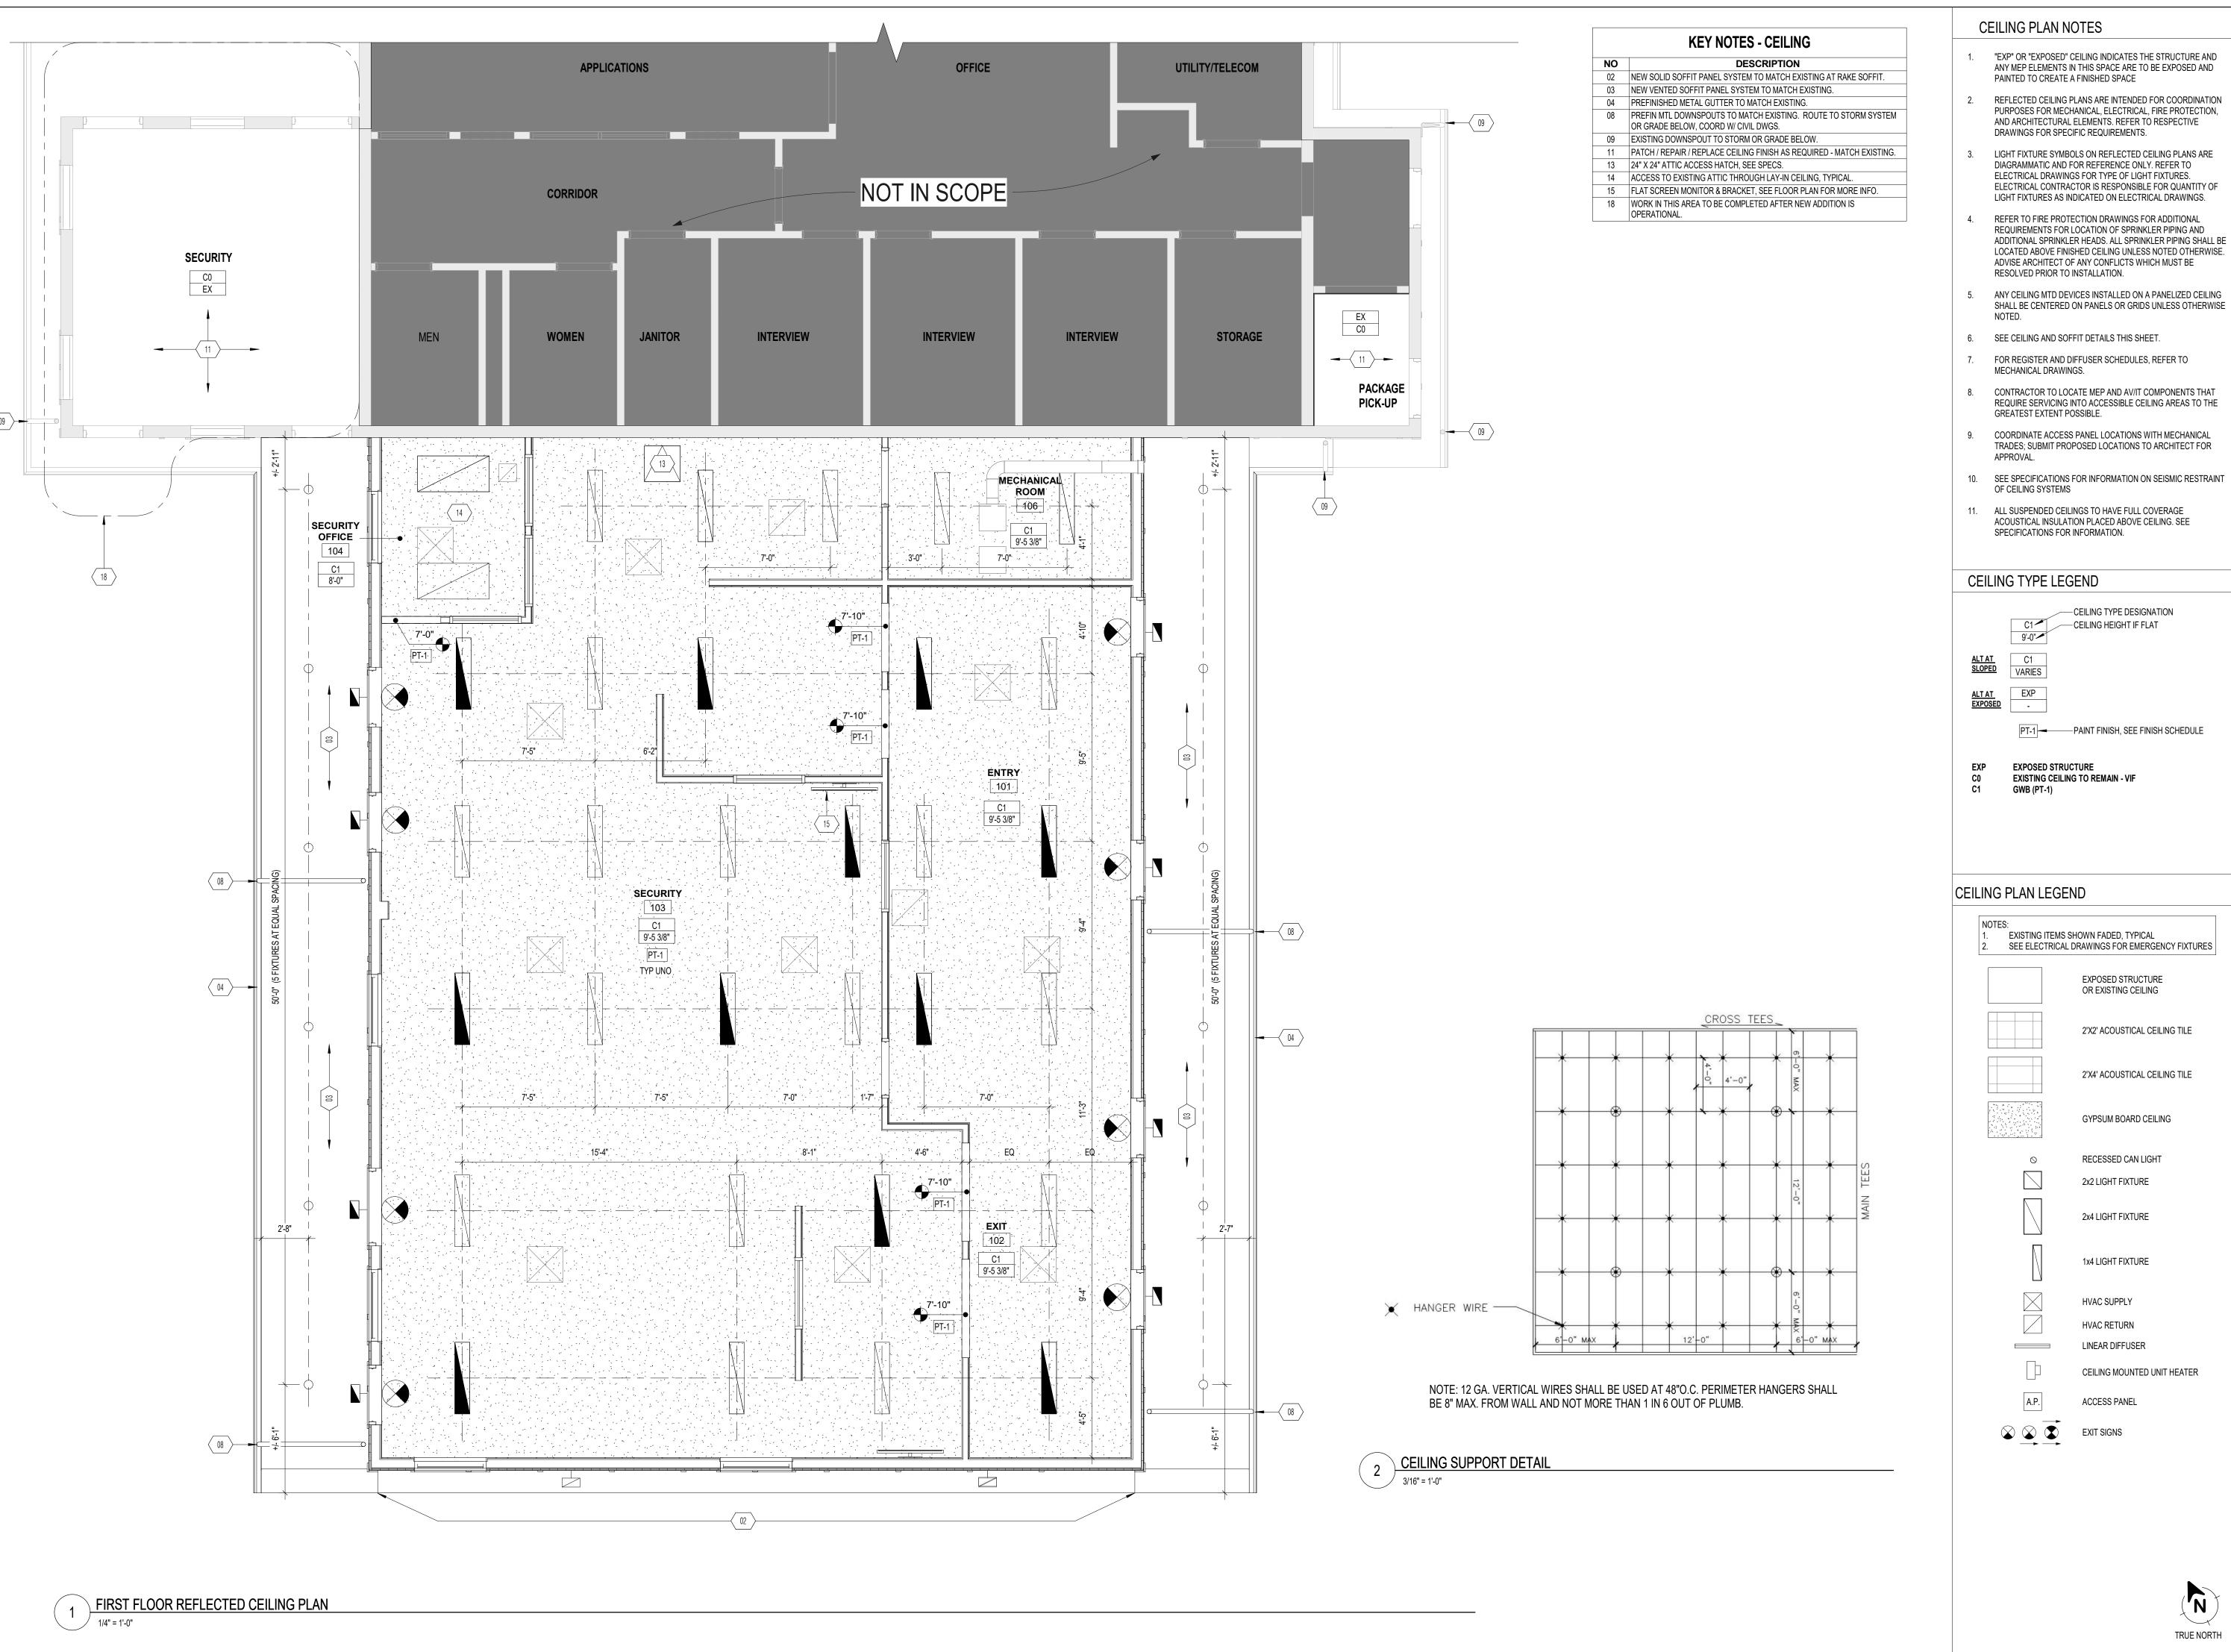"EXP" OR "EXPOSED" CEILING INDICATES THE STRUCTURE AND ANY MEP ELEMENTS IN THIS SPACE ARE TO BE EXPOSED AND

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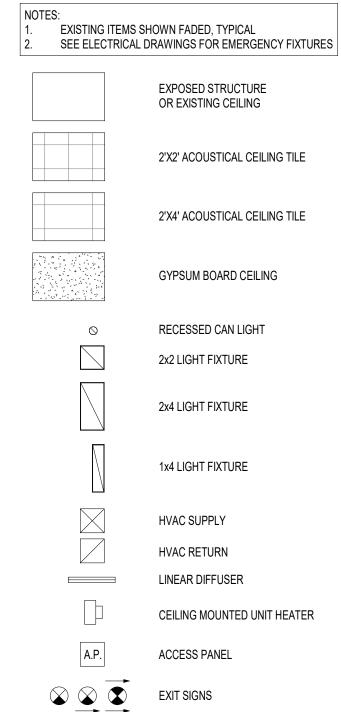


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WAY BUILDII 40 KENNED SOUTH WINDSC


GATEWAY



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REFLECTED CEILING PLAN

TRUE NORTH

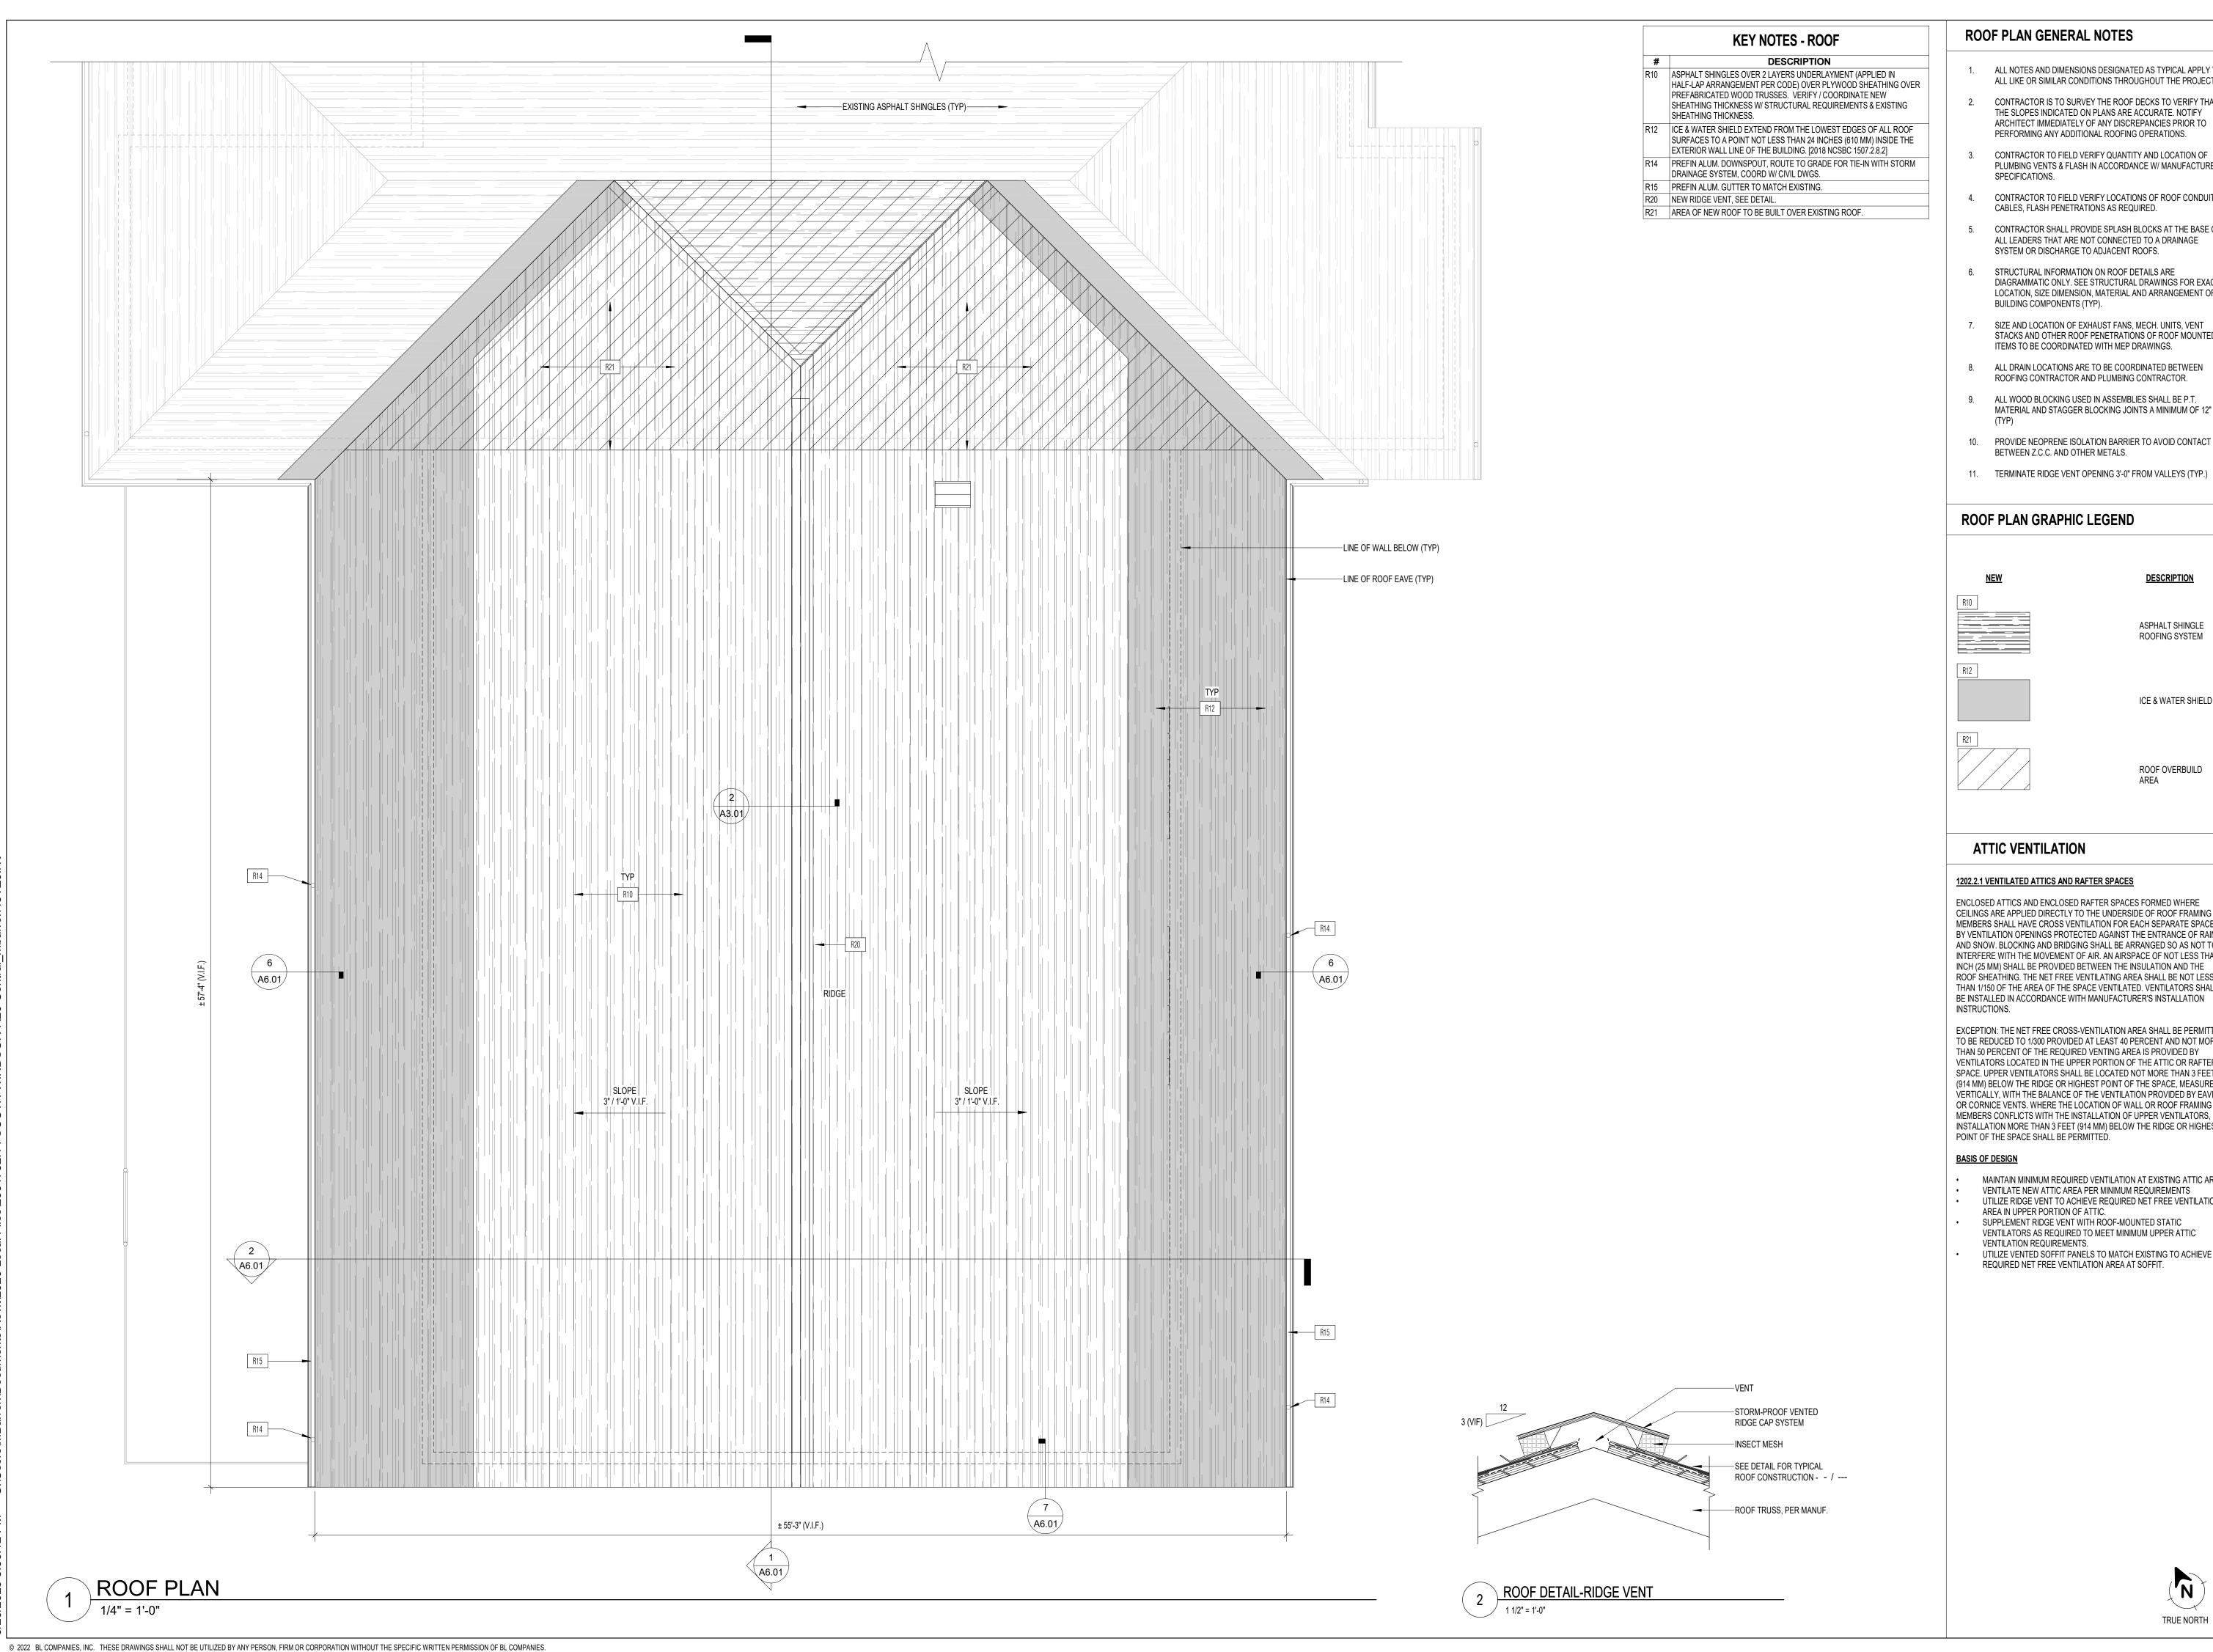


ROOF PLAN GENERAL NOTES

ALL NOTES AND DIMENSIONS DESIGNATED AS TYPICAL APPLY TO ALL LIKE OR SIMILAR CONDITIONS THROUGHOUT THE PROJECT.

- CONTRACTOR IS TO SURVEY THE ROOF DECKS TO VERIFY THAT THE SLOPES INDICATED ON PLANS ARE ACCURATE. NOTIFY
- PERFORMING ANY ADDITIONAL ROOFING OPERATIONS. CONTRACTOR TO FIELD VERIFY QUANTITY AND LOCATION OF PLUMBING VENTS & FLASH IN ACCORDANCE W/ MANUFACTURERS
 - SPECIFICATIONS. CONTRACTOR TO FIELD VERIFY LOCATIONS OF ROOF CONDUITS &
 - CABLES, FLASH PENETRATIONS AS REQUIRED.
- CONTRACTOR SHALL PROVIDE SPLASH BLOCKS AT THE BASE OF ALL LEADERS THAT ARE NOT CONNECTED TO A DRAINAGE SYSTEM OR DISCHARGE TO ADJACENT ROOFS.
- STRUCTURAL INFORMATION ON ROOF DETAILS ARE DIAGRAMMATIC ONLY. SEE STRUCTURAL DRAWINGS FOR EXACT LOCATION, SIZE DIMENSION, MATERIAL AND ARRANGEMENT OF BUILDING COMPONENTS (TYP).
- SIZE AND LOCATION OF EXHAUST FANS, MECH. UNITS, VENT STACKS AND OTHER ROOF PENETRATIONS OF ROOF MOUNTED ITEMS TO BE COORDINATED WITH MEP DRAWINGS.
- 8. ALL DRAIN LOCATIONS ARE TO BE COORDINATED BETWEEN ROOFING CONTRACTOR AND PLUMBING CONTRACTOR.
- 9. ALL WOOD BLOCKING USED IN ASSEMBLIES SHALL BE P.T. MATERIAL AND STAGGER BLOCKING JOINTS A MINIMUM OF 12"
- 10. PROVIDE NEOPRENE ISOLATION BARRIER TO AVOID CONTACT BETWEEN Z.C.C. AND OTHER METALS.
- 11. TERMINATE RIDGE VENT OPENING 3'-0" FROM VALLEYS (TYP.)

ROOF PLAN GRAPHIC LEGEND

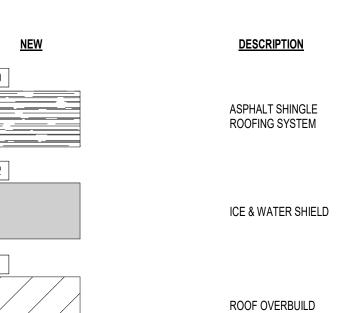

AREA

ATTIC VENTILATION

1202.2.1 VENTILATED ATTICS AND RAFTER SPACES

ENCLOSED ATTICS AND ENCLOSED RAFTER SPACES FORMED WHERE CEILINGS ARE APPLIED DIRECTLY TO THE UNDERSIDE OF ROOF FRAMING MEMBERS SHALL HAVE CROSS VENTILATION FOR EACH SEPARATE SPACE BY VENTILATION OPENINGS PROTECTED AGAINST THE ENTRANCE OF RAIN AND SNOW. BLOCKING AND BRIDGING SHALL BE ARRANGED SO AS NOT TO INTERFERE WITH THE MOVEMENT OF AIR. AN AIRSPACE OF NOT LESS THAN 1 INCH (25 MM) SHALL BE PROVIDED BETWEEN THE INSULATION AND THE ROOF SHEATHING. THE NET FREE VENTILATING AREA SHALL BE NOT LESS THAN 1/150 OF THE AREA OF THE SPACE VENTILATED. VENTILATORS SHALL BE INSTALLED IN ACCORDANCE WITH MANUFACTURER'S INSTALLATION INSTRUCTIONS.

EXCEPTION: THE NET FREE CROSS-VENTILATION AREA SHALL BE PERMITTED TO BE REDUCED TO 1/300 PROVIDED AT LEAST 40 PERCENT AND NOT MORE THAN 50 PERCENT OF THE REQUIRED VENTING AREA IS PROVIDED BY VENTILATORS LOCATED IN THE UPPER PORTION OF THE ATTIC OR RAFTER SPACE. UPPER VENTILATORS SHALL BE LOCATED NOT MORE THAN 3 FEET (914 MM) BELOW THE RIDGE OR HIGHEST POINT OF THE SPACE, MEASURED VERTICALLY, WITH THE BALANCE OF THE VENTILATION PROVIDED BY EAVE OR CORNICE VENTS. WHERE THE LOCATION OF WALL OR ROOF FRAMING MEMBERS CONFLICTS WITH THE INSTALLATION OF UPPER VENTILATORS, INSTALLATION MORE THAN 3 FEET (914 MM) BELOW THE RIDGE OR HIGHEST POINT OF THE SPACE SHALL BE PERMITTED.

- MAINTAIN MINIMUM REQUIRED VENTILATION AT EXISTING ATTIC AREA VENTILATE NEW ATTIC AREA PER MINIMUM REQUIREMENTS UTILIZE RIDGE VENT TO ACHIEVE REQUIRED NET FREE VENTILATION AREA IN UPPER PORTION OF ATTIC.
- SUPPLEMENT RIDGE VENT WITH ROOF-MOUNTED STATIC VENTILATORS AS REQUIRED TO MEET MINIMUM UPPER ATTIC VENTILATION REQUIREMENTS.
- UTILIZE VENTED SOFFIT PANELS TO MATCH EXISTING TO ACHIEVE REQUIRED NET FREE VENTILATION AREA AT SOFFIT.



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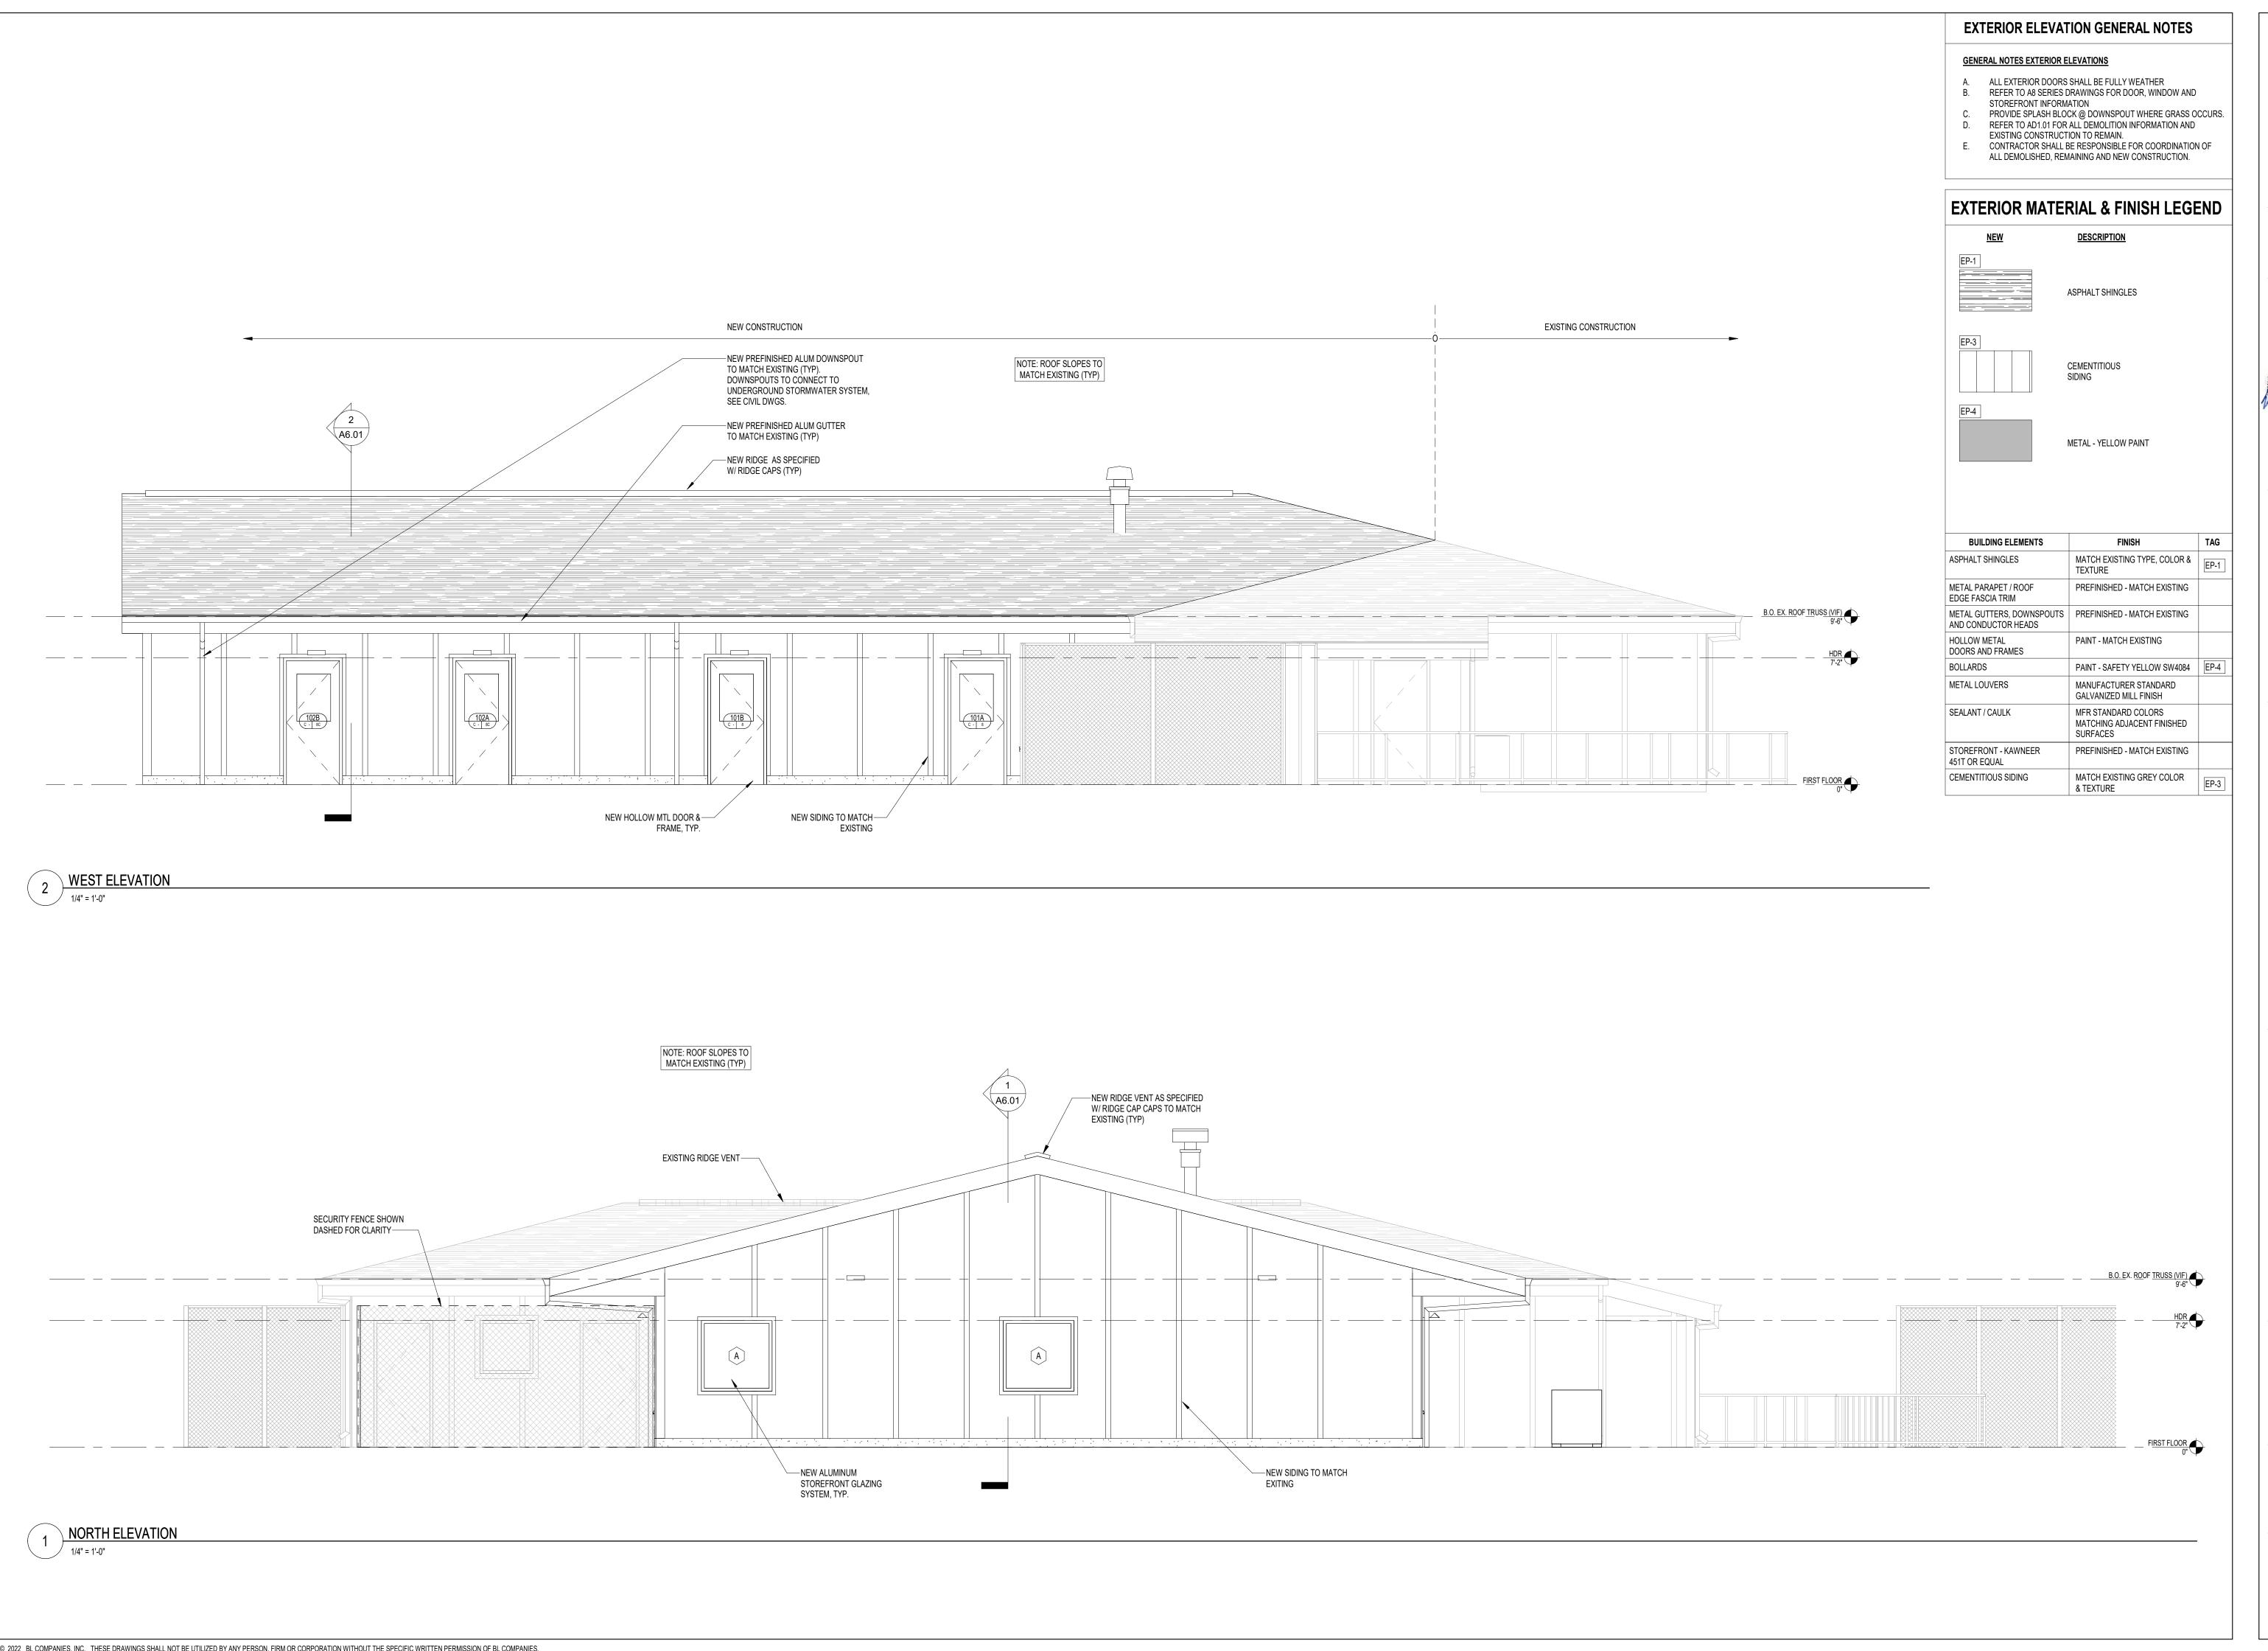
XPANSION FEWAY BUILDIN 40 KENNED SOUTH WINDSC

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ROOF PLAN & DETAILS

TRUE NORTH



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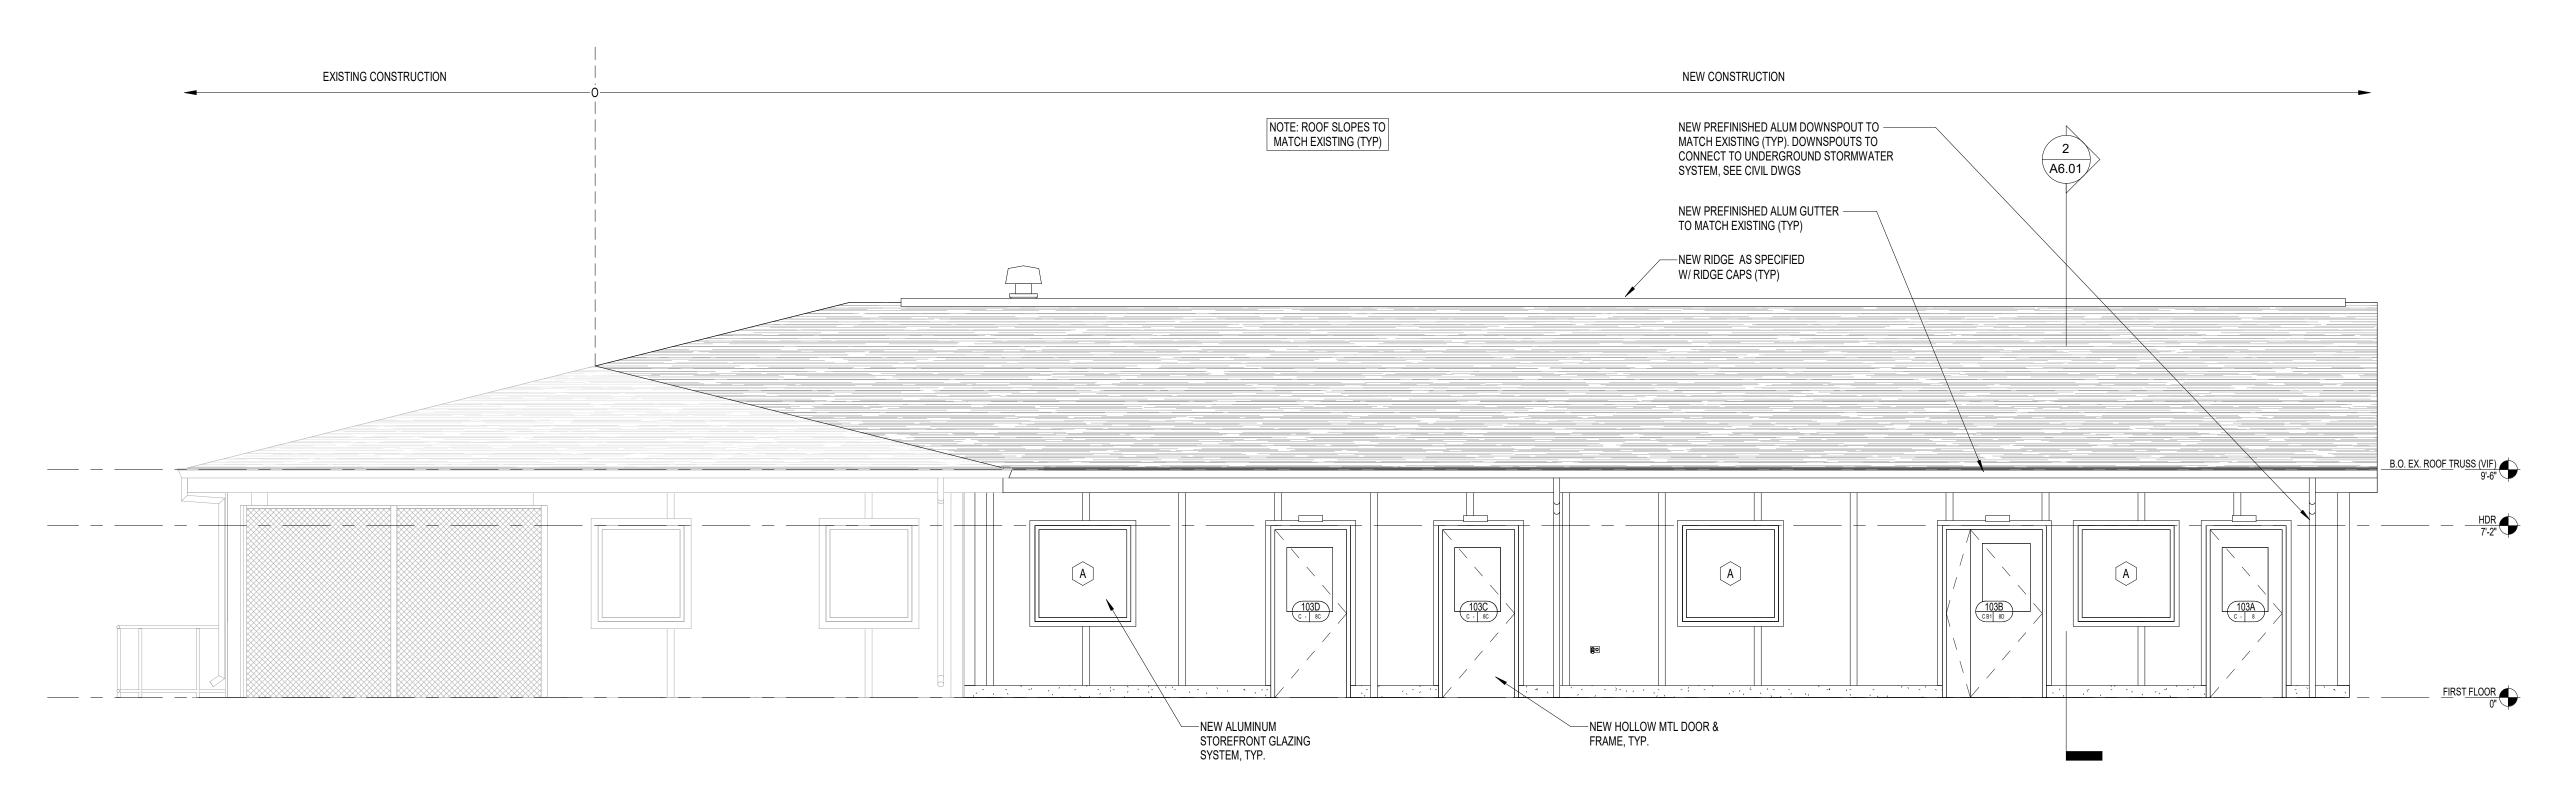


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EXTERIOR ELEVATIONS

A5.01




EXTERIOR ELEVATION GENERAL NOTES

GENERAL NOTES EXTERIOR ELEVATIONS

- A. ALL EXTERIOR DOORS SHALL BE FULLY WEATHER
- B. REFER TO AS SERIES DRAWINGS FOR DOOR, WINDOW AND STOREFRONT INFORMATION
- C. PROVIDE SPLASH BLOCK @ DOWNSPOUT WHERE GRASS OCCURS.D. REFER TO AD1.01 FOR ALL DEMOLITION INFORMATION AND
- EXISTING CONSTRUCTION TO REMAIN.

 E. CONTRACTOR SHALL BE RESPONSIBLE FOR COORDINATION OF ALL DEMOLISHED, REMAINING AND NEW CONSTRUCTION.

ATERIOR MATERIAL O FINIOLI LEOFNE

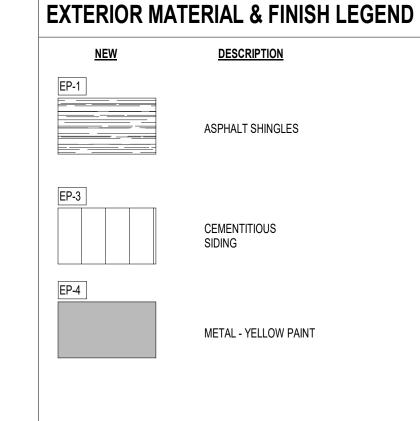

BUILDING ELEMENTS	FINISH
ASPHALT SHINGLES	MATCH EXISTING TYPE, COLOR & TEXTURE
METAL PARAPET / ROOF EDGE FASCIA TRIM	PREFINISHED - MATCH EXISTING
METAL GUTTERS, DOWNSPOUTS AND CONDUCTOR HEADS	PREFINISHED - MATCH EXISTING
HOLLOW METAL DOORS AND FRAMES	PAINT - MATCH EXISTING
BOLLARDS	PAINT - SAFETY YELLOW SW4084
METAL LOUVERS	MANUFACTURER STANDARD GALVANIZED MILL FINISH
SEALANT / CAULK	MFR STANDARD COLORS MATCHING ADJACENT FINISHED SURFACES
STOREFRONT - KAWNEER 451T OR EQUAL	PREFINISHED - MATCH EXISTING
CEMENTITIOUS SIDING	MATCH EXISTING GREY COLOR & TEXTURE

GATEWAY BUILDING EXPANSION
40 KENNEDY ROAD
SOUTH WINDSOR, CT 06074

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Date: 03-29-2023

DESCRIPTION

DATE


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EXTERIOR ELEVATIONS

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A5.02



Date: 03-29-2023

WAY BUILDII 40 KENNED SOUTH WINDSC

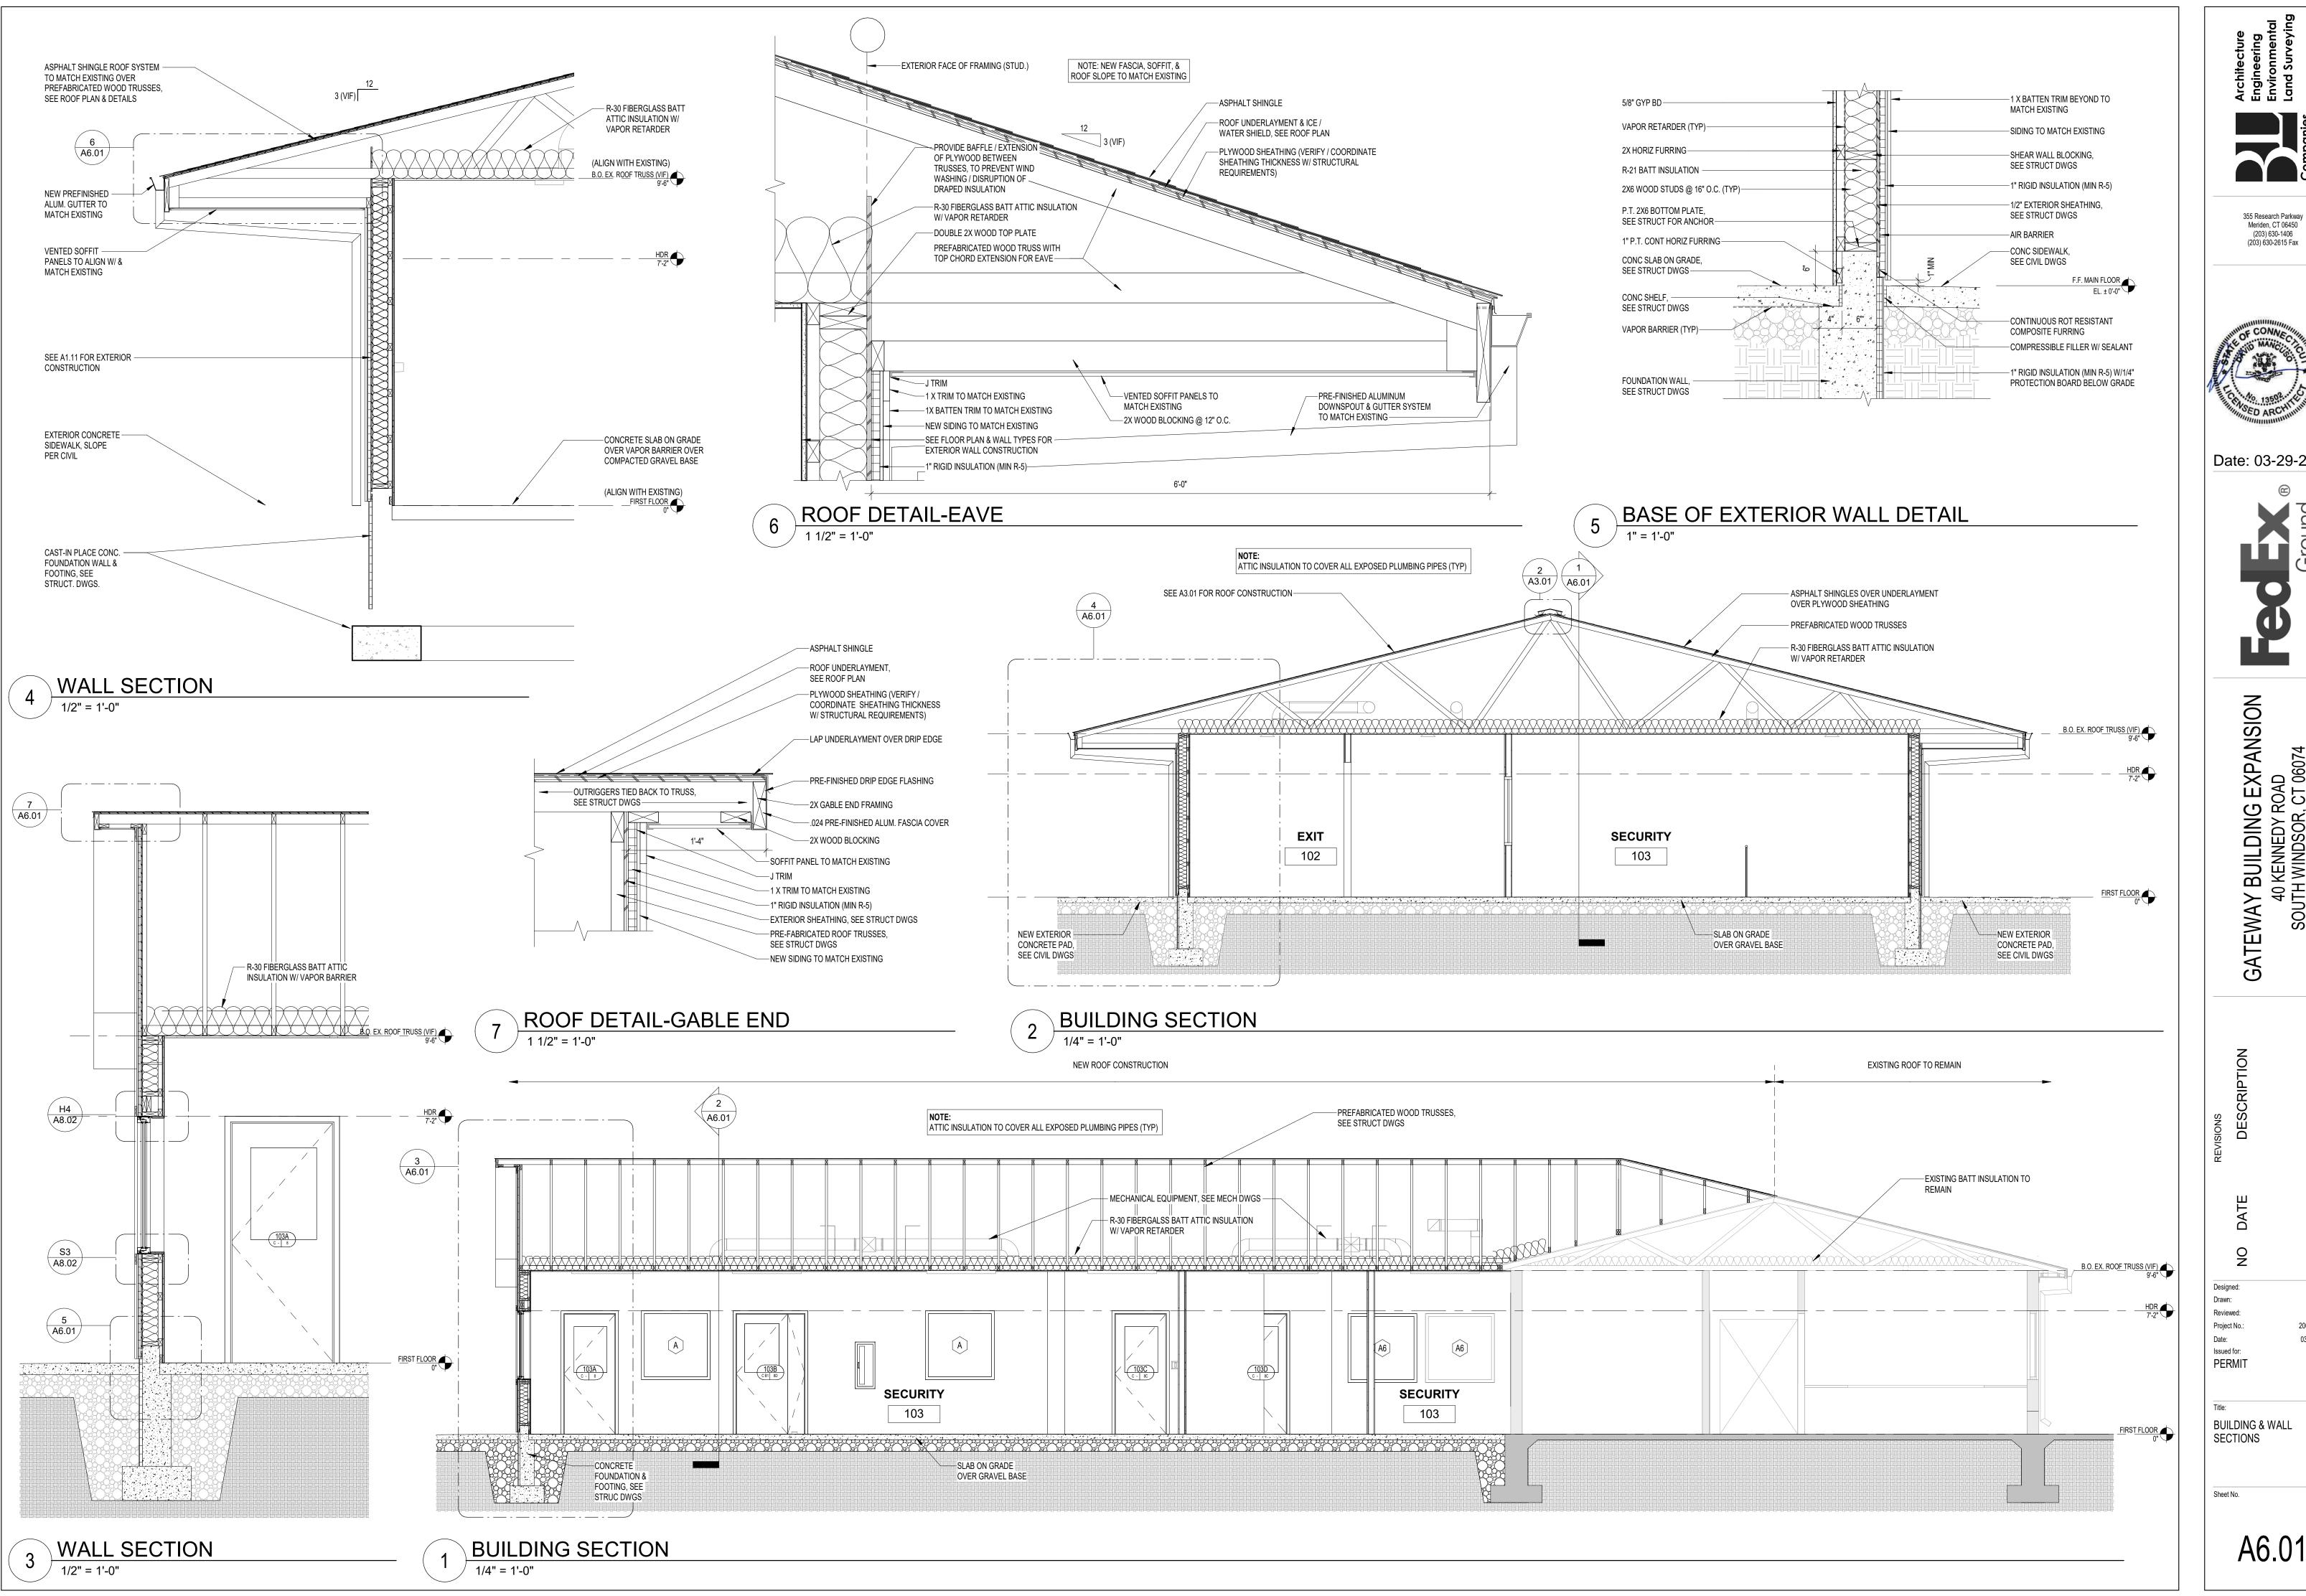2001752.14 03/29/2023

BUILDING & WALL

A6.01

	GLAZING S	SCHEDULE	GENERAL WINDOW NOTES						
TYPE	DESCRIPTION	USE IN THESE LOCATIONS	1. ALL WINDOW SIZES MUST BE VERIFIED IN FIELD. CONTRACTOR TO VERIFY ROUGH OPENINGS AND						
A	1/4" CLEAR GLASS		COORDINATE WITH GLAZING UNITS.						
(AT)	1/4" CLEAR TEMPERED GLASS	ALL INTERIOR NON-FIRE RATED DOORS & WINDOWS	2. COORDINATE FRAMES SIZES WITH SPECIFIED WINDOW SYSTEMS. TYPICAL FRAME AND MULLION SIZES TO						
(BT)	1/2" CLEAR TEMPERED GLASS		MEET SELECTED MANUFACTURER. SEE ALUMINUM ELEVATIONS FOR WINDOW SIZES AND SPECIFIED DESIGN DIMENSIONS FOR MORE INFORMATION.						
(DT)	1/2" INSULATED LOW-E TEMPERED GLASS	ALL EXTERIOR DOORS, WINDOWS, STOREFRONT & CURTAIN WALL	3. COORDINATE REQUIRED FRAME BRACING WITH SPECIFIED WINDOWS, STOREFRONT MANUFACTURER.						
(RT)	CLEAR LEVEL 3 BALLISTIC GLASS		SEE FRAME ELEVATIONS FOR WINDOW SIZES AND SPECIFIC DESIGN DIMENSIONS FOR MORE INFORMATION.						
			4. SEE DETAIL DRAWINGS FOR KEYED DETAILS.						
	LEG	END	5. NOT ALL WINDOWS DIMENSIONED AND KEYED ON SHEET. REFER TO LIKE WINDOW TYPES FOR DIMENSION AND KEYED DETAIL TAGS.						
	CLEAR GLASS		7. REFER TO SPEC FOR ALUMINUM WINDOW MANUFACTURERS. ALL EXTERIOR GLAZING ASSEMBLY FRAMES TO BE THERMALLY BROKEN.						
			8. 3M NIGHT VISION NV15 SUN CONTROL WINDOW FILM, APPLIED TO INTERIOR SURFACE OF GLASS WHERE CALLED OUT IN KEY NOTES CONSTRUCTION TAG - 11 ON SHEET A1.01.						

	DOOR AND FRAME SCHEDULE													
DOOR		DOOR						FRAME						
NUMBE		PANEL 1	PANEL 1	PANEL 2	PANEL 2			FRAME		HEAD	JAMB	SILL	HARDWARE	
R	ROOM NAME	TYPE	WIDTH	TYPE	WIDTH	HEIGHT	MATERIAL	TYPE	MATERIAL	DETAIL	DETAIL	DETAIL	SET	REMARKS
101A	ENTRY	С	3'-0"	-	0"	7'-0"	HM	F1	HM	H2	J2	S2	8	
101B	ENTRY	С	3'-0"	-	0"	7'-0"	HM	F1	HM	H2	J2	S2	8	
102A	EXIT	С	3'-0"	-	0"	7'-0"	HM	F1	HM	H2	J2	S2	8C	
102B	EXIT	С	3'-0"	-	0"	7'-0"	HM	F1	HM	H2	J2	S2	8C	
102C	EXIT	С	3'-0"	-	0"	7'-0"	НМ	F1	НМ	H5	J5	S1	8B	LEVEL 3 BULLET RESISTANT DOOR SLAB & FRAME. LEVEL 3 BALLISTIC GLASS

F1

S2 8D

S2 8C S2 8C

H2

H2

J2


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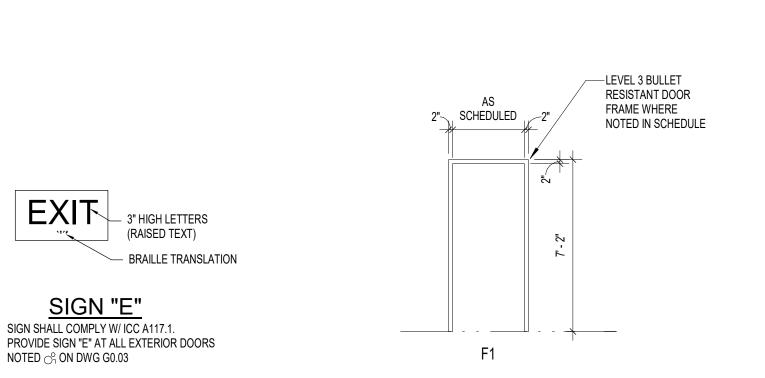
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AREA(S)	SET	QTY.	ITEM NO.	DESCRIPTION			
-Exterior to Security	#8D	1 ½ Pr. (Ea. Leaf)	BB1199	4 1/2" x 4 1/2" 32D NRP Hinges			
Building		1	L460BD 626	Deadbolt			
Confirm Set		1 (Active Leaf)	8200	4" x 16" US32D Push Plate			
w/ FXG Project		1 (Active Leaf)	8302-6	4" x 16" US32D Pull Plate			
Engineer & Hardware		1 (Active Leaf)	4040XP	CUSH 689 Closer			
Coordinator		1 (Active Leaf)	CS115-25	US26D Crash Stop			
		1 (Active Leaf)	8400	10" x 34" 32D Kickplate			
		1	By Reese or Other Approved Mfr	Threshold x 48"			
		1 Set	By Reese or Other Approved Mfr	Weatherstripping			
		1	323A	Door Sweep x 36"			
		1	323A	Door Sweep x 12"			
		1 (Active Leaf)	Per Hardware Coordinator	Astragal			
		1 Set (Inactive Leaf)	Per Hardware Coordinator	Flush Bolts			
		1 (Inactive Leaf)	Per Hardware Coordinator	Overhead Stop			







WINDOW TYPES

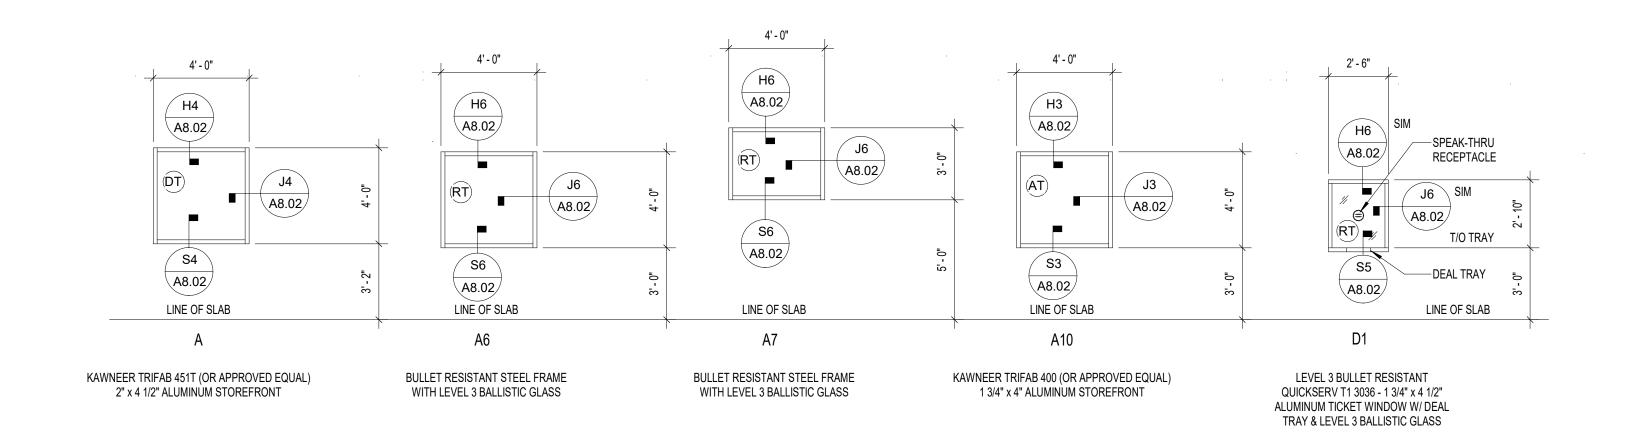—BLUE BACKGROUND

3/32" RAISED SYMBOL

1" BLUE BACKGROUND

(WHITE)

SIGN "C"

MOUNT ON INSIDE OF DOOR. PROVIDE SIGN "C"

SIGN DETAILS

AT ALL EXTERIOR DOORS NOTED 0, ON DWG G0.03

103A SECURITY
103B SECURITY

103C SECURITY

103D SECURITY

104 MECHANICAL ROOM

3'-0"

3'-0"

3'-0"

B1 3'-0"

1'-0"

0"

0"

7'-0"

7'-0"


7'-0"

7'-0"

HM

HM



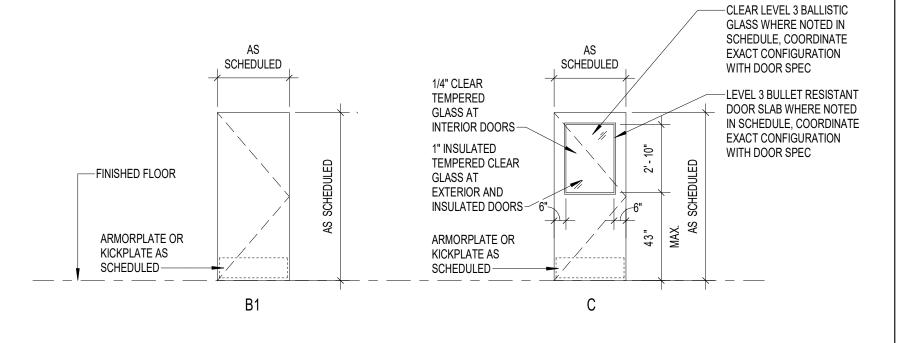



Architecture Engineering Environmental Land Surveying

DOORS AND FRAMES GENERAL NOTES

 ALL DOORS ARE 1 3/4" UNLESS OTHERWISE NOTED
 ALL INTERIOR GLAZING IS TO BE 1/4" GLASS AND EXTERIOR GLAZING IS TO BE 1" INSULATED GLASS UNLESS OTHERWISE

ALL EXTERIOR HOLLOW METAL DOORS ARE INSULATED.
 REFER TO SPECIFICATION FOR HARDWARE SET

REFER TO WALL TYPES FOR FRAME DEPTH REQUIREMENTS
REFER TO DOOR DETAILS A8.02 FOR JAMB, HEAD AND SILL DETAILS
ALL DOORS TO HAVE STANDARD 5/16" UNDERCUT UNLESS
OTHERWISE INDICATED OR REQUIRED TO RECIEVE SCHEDULED

9. HOLLOW METAL DOORS & FRAMES TO BE PAINTED PT-2, TYPICAL


DESCRIPTIONS.

THRESHOLD.

NONSTANDARD HARDWARE SET

8. INDICATED FIRE RATING IS IN MINUTES

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Date: 03-29-2023

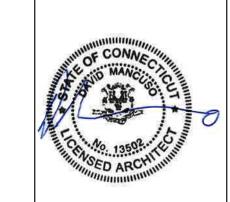

GATEWAY BUILDING EXPANSION
40 KENNEDY ROAD
SOUTH WINDSOR, CT 06074

DESCRIPTION

О DATE

Designed: DM
Drawn: RT
Reviewed: MG
Project No.: 2001752.14
Date: 03/29/2023
Issued for:


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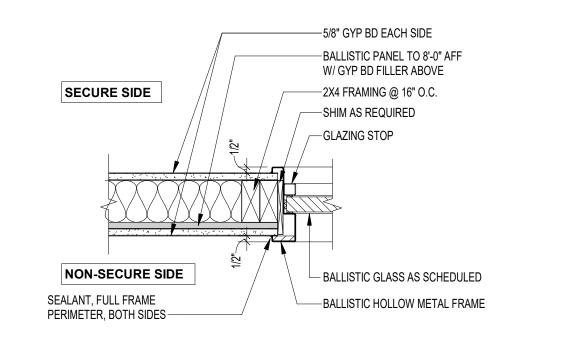
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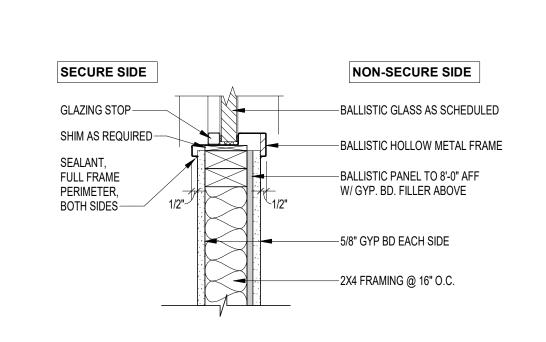
DOOR AND FRAME TYPES
AND SCHEDULE

Sheet No.

A8.01






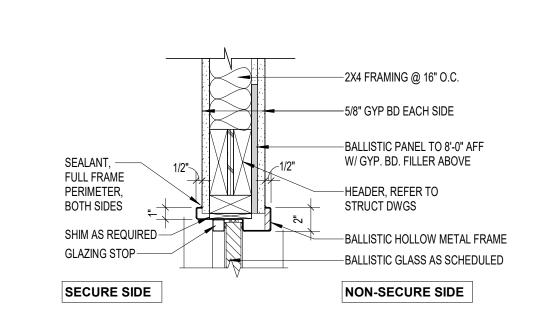










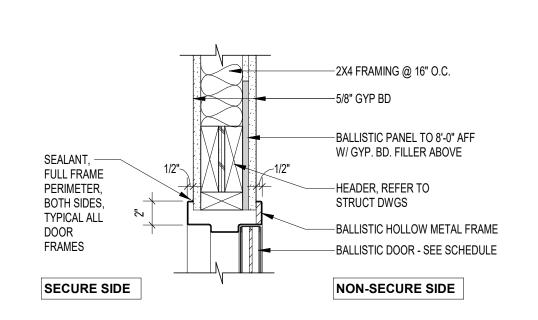

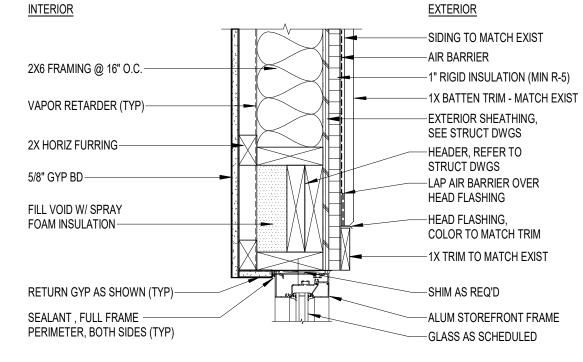

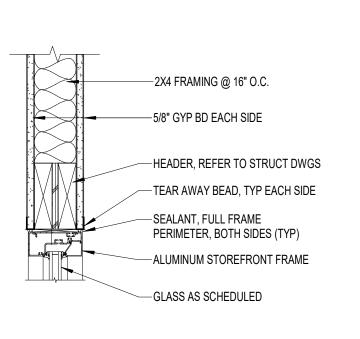

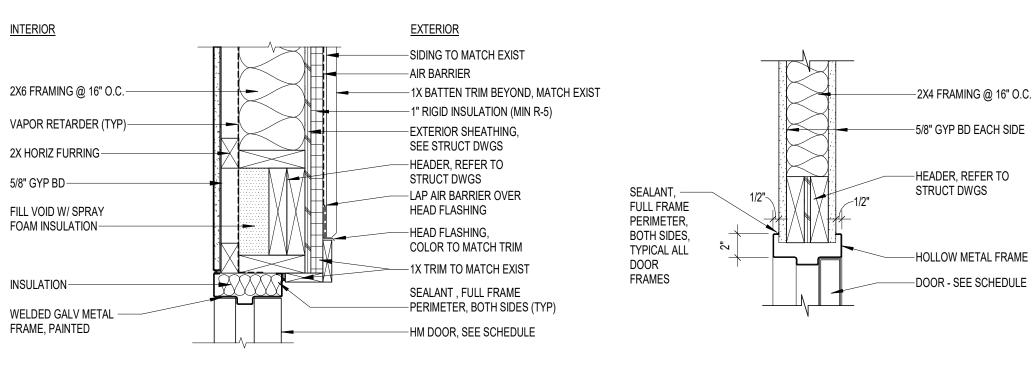
















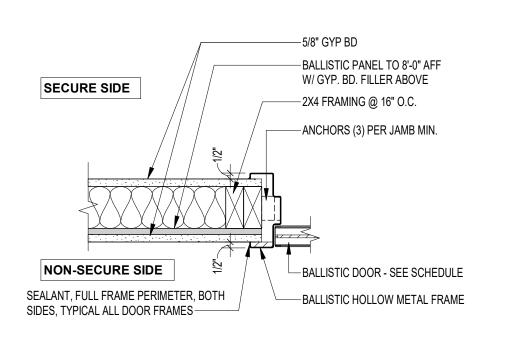

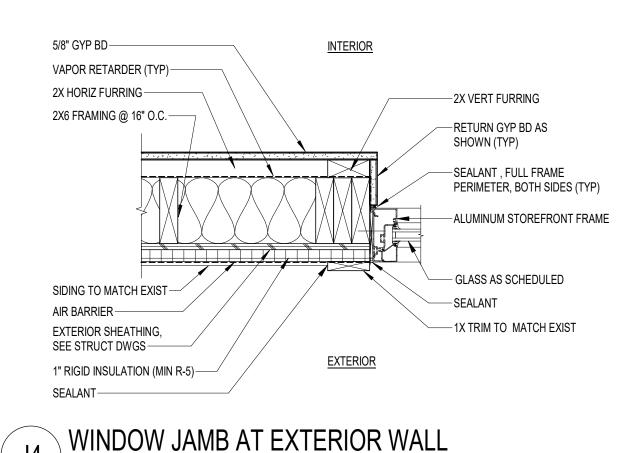


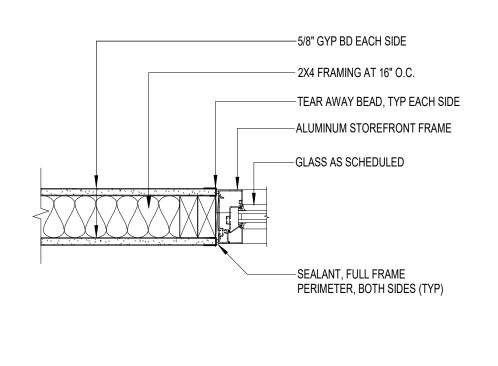

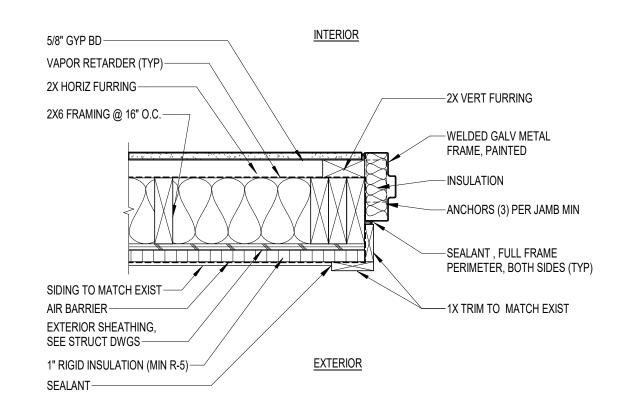


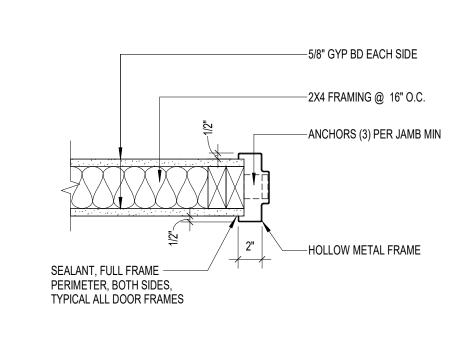




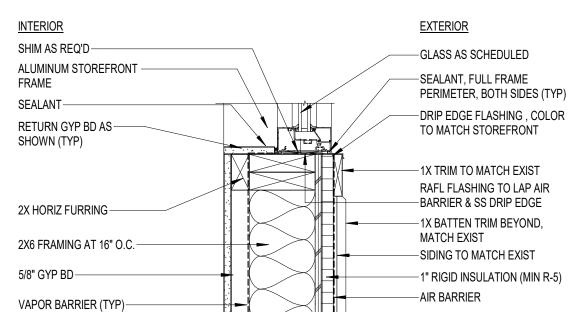





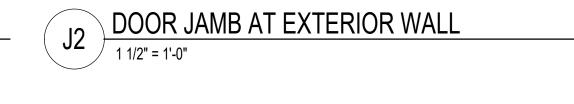





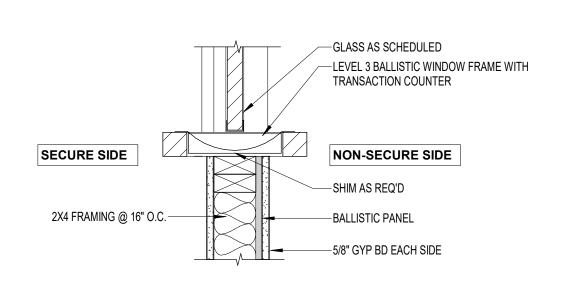

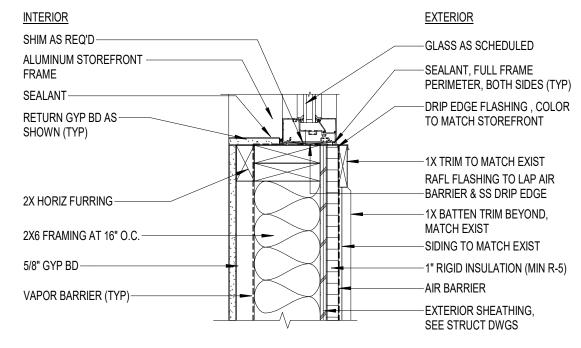

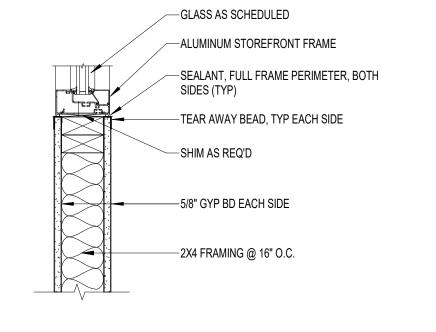

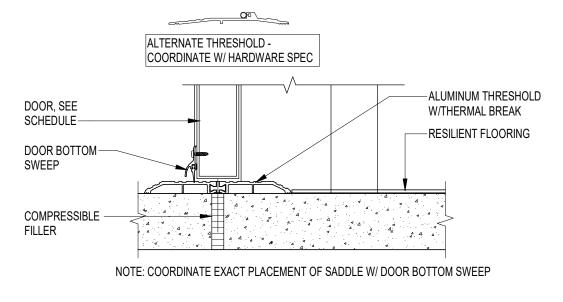

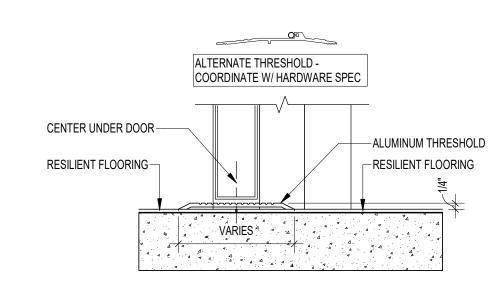

TRANSACTION WINDOW SILL AT INTERIOR WALL

WINDOW SILL AT EXTERIOR WALL

1 1/2" = 1'-0"










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Date: 03-29-2023

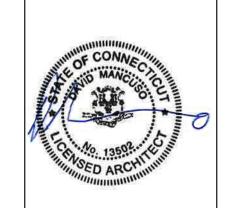


EXPANSION NG WAY BUILDII 40 KENNED SOUTH WINDSC **GATEWAY**


Reviewed: 2001752.14 Project No.: 03/29/2023 Date: Issued for: PERMIT


DOOR & WINDOW DETAILS


Sheet No.

A8.02

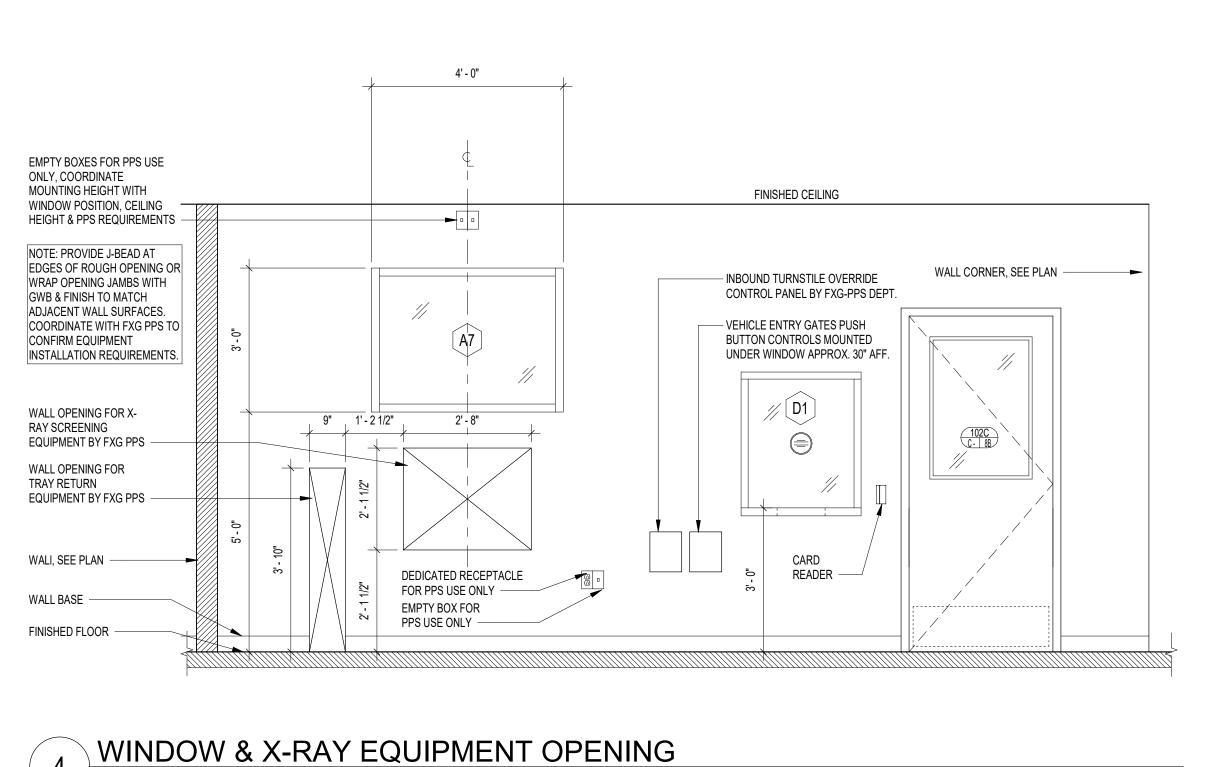

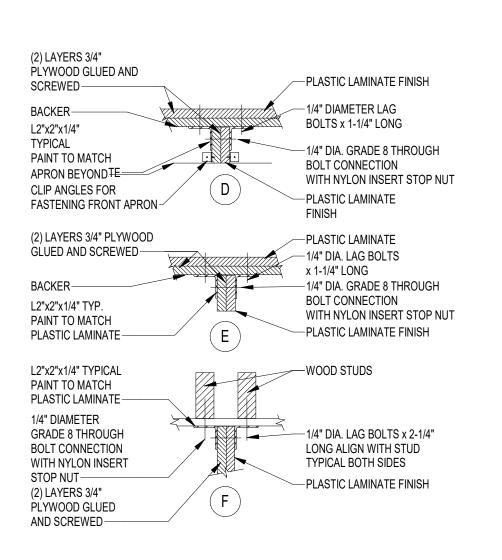

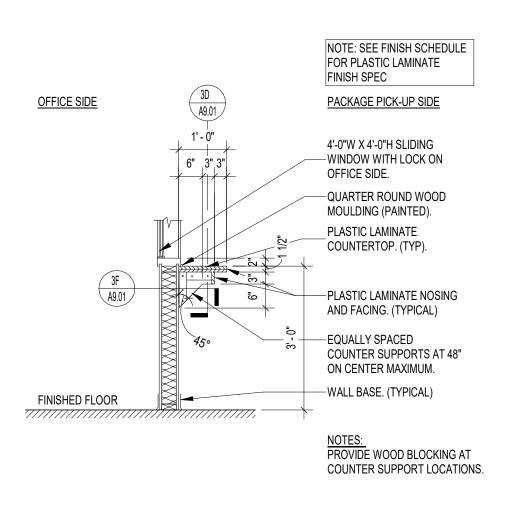

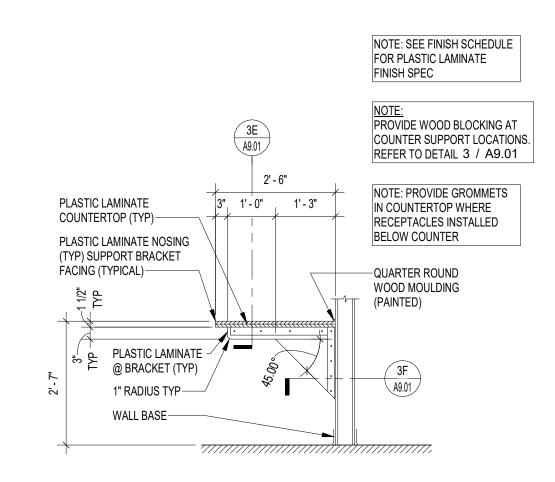


COUNTER DETAILS

PACKAGE PICK-UP SECTION (FXG-06211-014 SIM)

31" HIGH COUNTER TYPICAL SECTION



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GATEWAY BUILDING EXPANSION 40 KENNEDY ROAD SOUTH WINDSOR, CT 06074

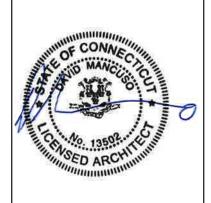
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MISC DETAILS

Sheet No.

A9.01

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EXPANSION ING EXPANDY ROADSOR, CT 06074 WAY BUILDIN 40 KENNED SOUTH WINDSC GATEWAY

Reviewed: Project No.:

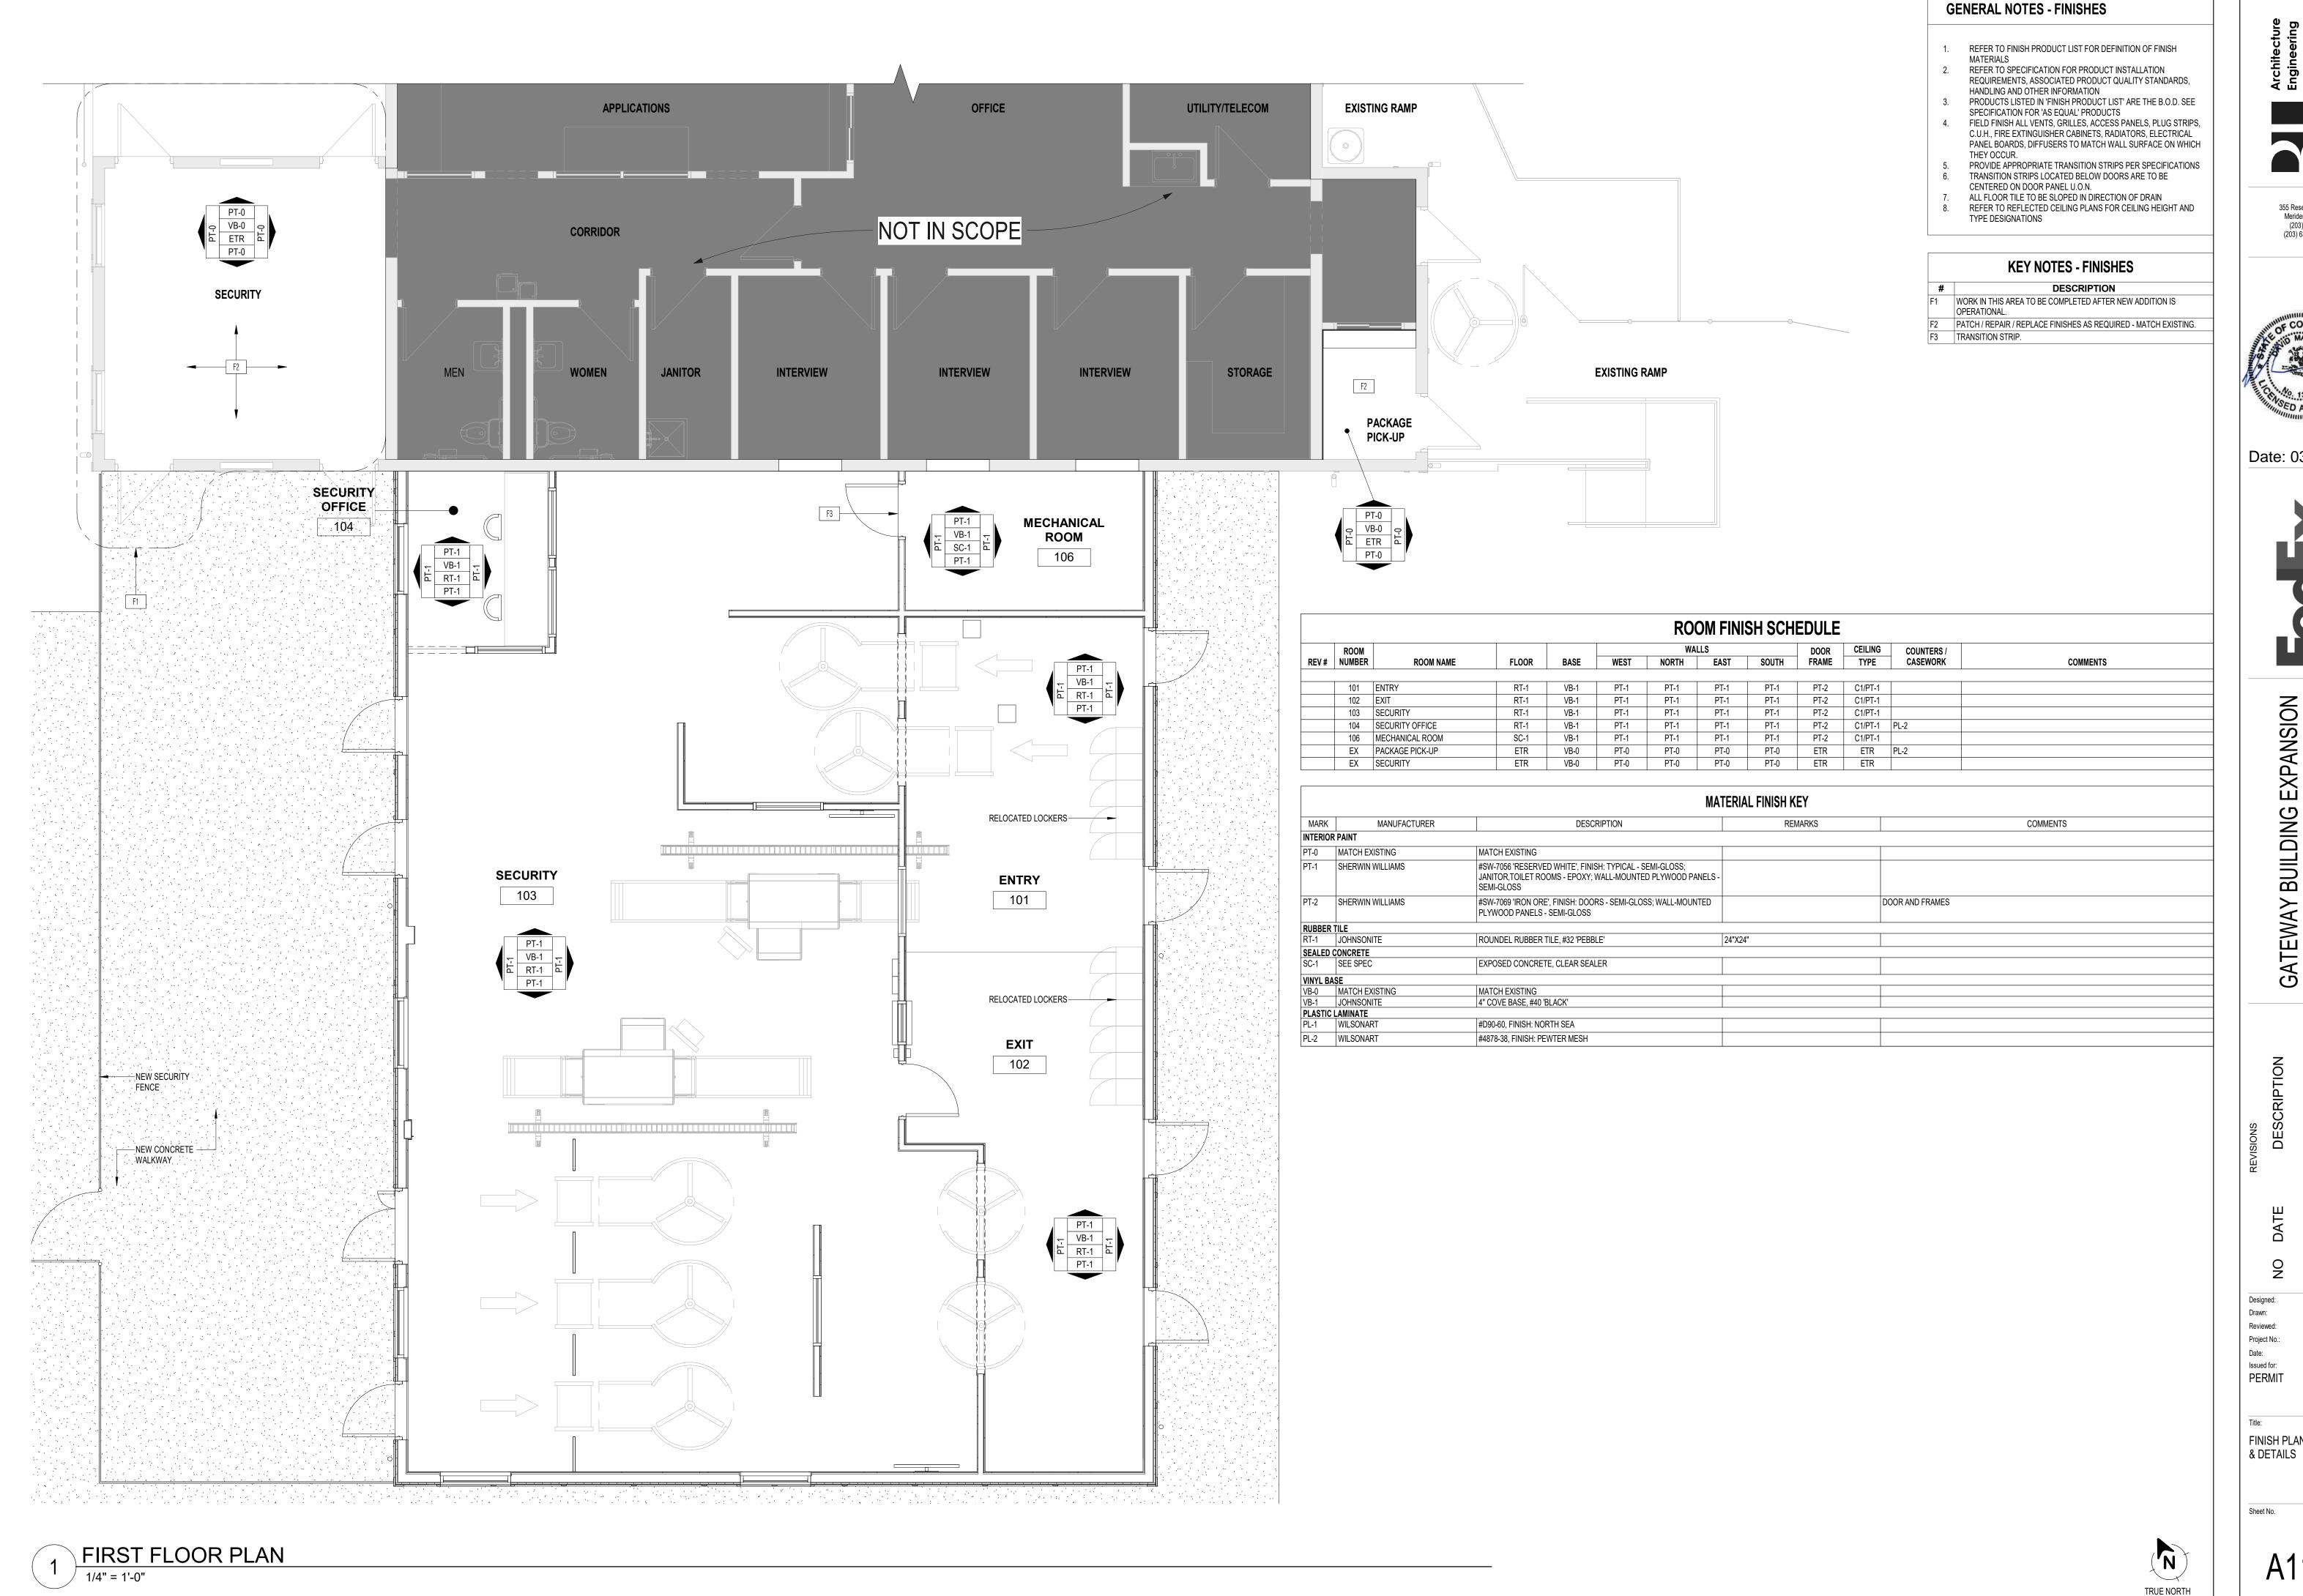Issued for: PERMIT

FINISH PLAN, SCHEDULES

Approver 2001752.14

03/29/2023